

Civil Site Planning Environmental Engineering 133 Court Street Portsmouth, NH 03801-4413

November 1, 2021

Peter Britz, Interim Planning Director City of Portsmouth, Planning Department 1 Junkins Ave, 3rd Floor. Portsmouth, New Hampshire 03801

Re: TAC Work Session Application 960 Sagamore Avenue, Portsmouth, NH Tax Map 201, Lot 2 Altus P5079

Dear Peter,

Katz Development Corporation (KDC) is proposing to redevelop the property formerly occupied by the Golden Egg Restaurant located at 960 Sagamore Avenue. KDC has obtained relief from the Zoning Board of Adjustment to construct 6-residential condominium units. Altus Engineering, Inc. (Altus) is preparing the site plan application for the redevelopment. We have submitted preliminary plans showing the proposed site development, which includes:

- Demolishing the existing building and removing all of the associated site features.
- Siting the new building completely outside of the wetland buffer.
- Removal of head-in parking and access from Sagamore Avenue and pavement and parking in the Sagamore Ave right-of-way.
- Removal of approximately 765 sqft of gravel parking area from the 100 ft wetland buffer.
- A small patio will be located in the buffer and the existing propane tank will be replaced with an underground tank.
- Per zoning approval, there will be two driveway accesses from Sagamore Grove, on to the basement parking area and one to a visitor parking lot at the rear of the building.
- Provide stormwater management to a site where none currently exists. Treatment will be provided with sub-surface chambers to collect the roof runoff and porous pavement for the rear parking lot area.
- A four foot high retaining wall is proposed between the building and Sagamore Avenue to soften the grading.
- Landscaping will be provided along Sagamore Avenue (to be included in application)
- Provide curbing along Sagamore Ave, where parking is removed.
- The total site disturbance is approximately 26,500 sqft.

KDC plans to have the project complete and ready for occupancy by February 2023. We understand that the City of Portsmouth has a Consent Decree agreement with the EPA to extend sewer to the Sagamore Creek area. The sewer extension design for the low-pressure force main to service this area including the subject property has been completed, but the definitive timetable for completion is undetermined. We are proposing to install the E-one low pressure pump system for the facility, but will may need to install a temporary sanitary holding tank that that would be pumped regularly if the sewer is not complete.

Similarly, we are proposing to connect the water service to the new 8" water main in Sagamore Grove that will be constructed with the new LPSS main. If the new water main, is not completed, the water service will connect to the existing water main and be reconnected when the new water main is installed.

Altus looks forward to discussing this project with TAC at the Nov. 9 Work Session.

Sincerely,

ALTUS ENGINEERING, INC.

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Cory D. Belden, P.E.

5079 TAC-WS ltr 102921.docx

Ecopy: Eric Katz, KDC Eric Weinrieb, Altus Engineering

Site Redevelopment Plans PROPOSED MULTI-FAMILY RESIDENTIAL DEVELOPMENT

Owner:

SAGAMORE CORNER, LLC


273 CORPORATE DRIVE PORTSMOUTH, NH 03801

Applicant:

KATZ DEVELOPMENT CORPORATION

273 CORPORATE DRIVE PORTSMOUTH, NH 03801

Civil Engineer:

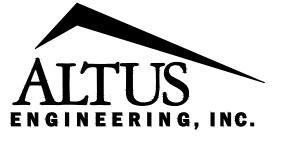

133 COURT STREETPORTSMOUTH, NH 03801(603) 433-2335www.ALTUS-ENG.com

Sur veyor:

James Verra and Associates, Inc. LAND SURVEYORS

101 SHATTUCK WAY - SUITE 8 NEWINGTON, N.H. 03801- 7876 603-436-3557

Ar chitect:



JSA ARCHITECTURE | PLANINNG | INTERIORS

273 CORPORATE DRIVE, SUITE 100 PORTSMOUTH NH 03801 603.436.2551 INFO@JSAINC.COM

Landscape Architect:



Landscape Architecture, LLC

103 Kent Place Newmarket, NH 03857 Tel 603.659.5949 Fax: 603.659.5939


960 SAGAMORE AVENUE PORTSMOUTH, NH 03801

TAX MAP 201, LOT 2

Issued for:

NOVEMBER 2, 2021

TAC WORK SESSION

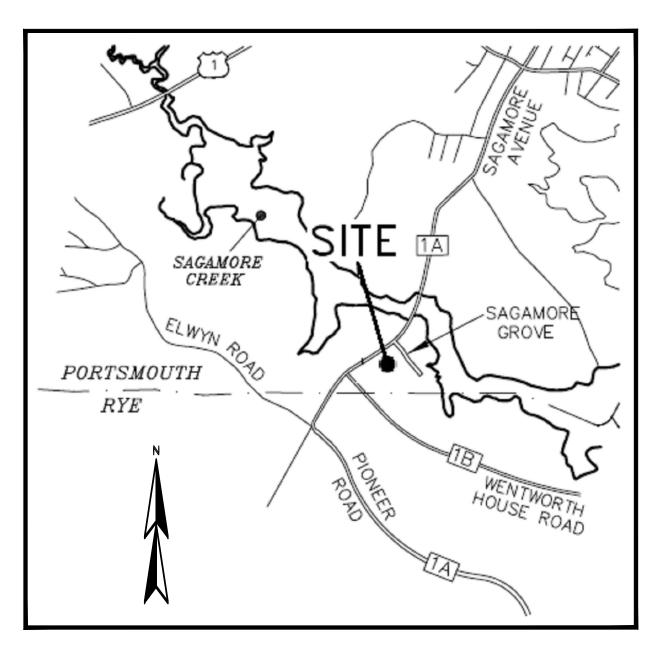

Locus Map Scale: Not to Scale

Sheet Index Title

Existing Condition Demolition Plan Site Plan Grading and Drain Utilities Plan Erosion Control No Construction Deta Construction Deta Construction Detai Construction Detai Construction Deta Site Lighting Plan Landscape Plan (b Landscape Details Building Floor Plan Exterior Elevations


Reference: 90% Sagamore Gro (Wright-Pierce

 SECTION 10.1114.31 - TO ALLOW TWO (2) DRIVEWAYS WHERE ONE (1) IS PERMITTED.
 ZONING SECTION 10.521 - TO ALLOW A DENSITY OF SIX (6) DWELLING UNITS WHERE 5.7 ARE PERMITTED.

	Shee No.:		Rev.	Date
s Plan (by JVA)	3 SHEETS	S 0		02/20/20
	C-1	0		11/02/21
	C-2	0		11/02/21
nage Plan	C-3	0		11/02/21
	C-4	0		11/02/21
lotes and Details	C-5	0		11/02/21
ails	C-6	0		11/02/21
ails	C-7	0		11/02/21
ails	C-8	0		11/02/21
ails	C-9	0		11/02/21
ails	C-10	0		11/02/21
n (by Visible Light, Inc.)	S-1	(NOT IN		•
by Woodburn & Co.)	L-1	(NOT IN		
s (by Woodburn & Co.)	L-2	(NOT IN	CLUDED))
ns (by JSA)	A-1	0		11/02/21
s (by JSA)	A-2	(NOT IN	CLUDED))
rove Sewer Extension ce)	C-3A			03/21

Permit Summary

ZONING - THE FOLLOWING TWO VARIANCES WERE GRANTED ON SEPTEMBER 21, 2021.

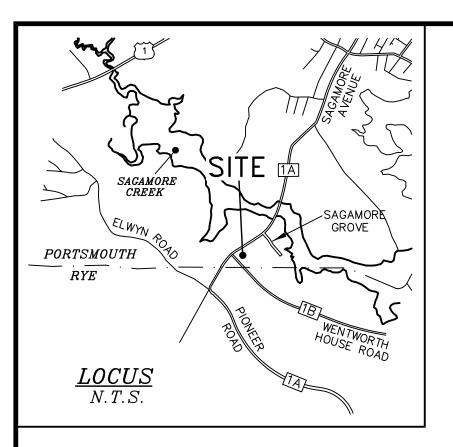


	LEGEND:			NOTES:		
	STONE WALL STONE WALL IRON ROD FOUND IRON ROD SET IRON PIPE FOUND DRILL HOLE SNHPUBLIC SERVICE CO. OF NH VZVERIZON		1.	OWNER OF RECORD ADDRESS DEED REFERENCE TAX SHEET / LOT TRUSTEES PARCEL AREA ZONED	960 SAGAMORE AVI 3469/2151 201–2 ARMAND E. GOSSEI FRANCES M. GOSSE 34,154 S.F. (0.784	E, PORTSMOUTH, NH 03801 LIN
F	A			OWNER OF RECORD ADDRESS DEED REFERENCE TAX SHEET / LOT PARCEL AREA ZONED	1150 SAGAMORE RI 6045/1665 201–9 59,243 S.F. (1.360	D, PORTSMOUTH, NH 03801
	ETWEDGE OF TRAVELLED WAY VGCVERTICAL FACED GRANITE CURB \oplus BOLLARD \blacksquare REFLECTOR \neg SIGN \neg DOUBLE POST SIGN			OWNER OF RECORD ADDRESS. DEED REFERENCE TAX SHEET / LOT PARCEL AREA ZONED	1150 SAGAMORE RI 6045/1667 201–10 31,857 S.F. (0.731	D, PORTSMOUTH, NH 03801
	ØUTILITY POLE ØUTILITY POLE W/TRANSFORMER \$LIGHT POLE O			DEED REFERENCE TAX SHEET / LOT PARCEL AREA	1150 SAGAMORE RI 6057/1042 201–11 14,186 S.F. (0.326	D, PORTSMOUTH, NH 03801
C			2.	ZONED MRB ZONED: MRB MINIMUM LOT AREA 7,500 S. FRONTAGE 100' ZONED: WB MINIMUM LOT AREA 20,000 S FRONTAGE 100'	F. FR SID RE S.F. SID S.F. SID	ONT YARD SETBACK5' DE YARD SETBACK10' AR YARD SETBACK15' ONT YARD SETBACK30' DE YARD SETBACK30' AR YARD SETBACK20'
			3. 4.	THE RELATIVE ERROR OF CLC THE LOCATION OF ALL UNDER APPROXIMATE AND ARE BASE	DSURE WAS LESS THAN RGROUND UTILITIES SHO ED UPON THE FIELD LO INS, MANHOLES, WATER	1 FOOT IN 15,000 FEET. DWN HEREON ARE CATION OF ALL VISIBLE GATES ETC.) AND INFORMATION
	-DDRAIN LINE -UGUUNDERGROUND UTILITIES -OHWOVERHEAD WIRES CEMENT CONCRETE		5.	AGENCIES. ALL CONTRACTOR PRIOR TO ANY EXCAVATION N ON SITE CONTROL ESTABLISH HORIZONTAL DATUM: NAD 19 VERTICAL DATUM: NAVD 1980 PRIMARY BM: CITY CONTROL	RS SHOULD NOTIFY, IN WORK AND CALL DIG-S IED USING SURVEY GRA 983 (2011) 8	WRITING, SAID AGENCIES AFE @ 1—888—DIG—SAFE.
	EQRIP RAP		6.	WETLANDS DELINEATION 12/2 6 YORK POND RD, YORK, ME	2015 & 11/2019 BY M 03909.	
;	<12.5SPOT GRADE		7.	DATED OCTOBER 18, 1995 & (ROUTE 1–B), PORTSMOUTH,	SHOWN ON "PLAN OF HIGHWAY EASEMENT".	RCRD BOOK 3123, PAGE 2896, WENTWORTH ROAD SAID PLAN IS NOT RECORDED D FOR OTHER RIGHTS GRANTED
			8.	RATE MAP NO. 33015CO286E	CHANCE FLOODPLAIN, A E, EFFECTIVE DATE MAY	AS SHOWN ON FLOOD INSURANCE / 17, 2005, BY FEMA.
	ABUTTERS LIST		9. 10.	THIS PLAN IS BASED ON A F JAMES VERRA AND ASSOCIAT	TES, INC.	2020 BY IDERLYING FEE OF THIS PORTION
<u>LOT</u> -1	OWNER OF RECORD 955 SAGAMORE REALTY TRUST – 3/12/2008 MICHAEL T. GOODRIDGE, TRUSTEE 39 FERRY RD, SALISBURY, MA 01952	<u>DEED REF.</u> 4903/695		OF THE ROAD REMAINS WITH ASSIGNS. SEE ACKNOWLEDGE CONTRACTOR TO VERIFY SITE	FRANCES & ARMAND MENT & RELEASE DATE BENCHMARKS BY LEV SETTING OR ESTABLISH	GOSSELIN, THEIR HEIRS, SUCCESSORS ED 3/17/1997, RCRD BOOK 3231, PAU ELING BETWEEN 2 HMENT OF ANY GRADES/ELEVATIONS.
—1	WILLIAM L. PINGREE 11 SAGAMORE GROVE, PORTSMOUTH, NH 03801	5796/1142		REFERENCE PLANS:		
3	LUCIAN SZMYD & DIANE M. SZMYD 41 HARBORVIEW DR, RYE, NH 03870	4547/2733	1.	PLAN OF LAND, 1150 SAGAM RYE CORNER GAS, LLC, DATE		
6	JASON GOULEMAS 2002 FAMILY TRUST JASON GOULEMAS, TRUSTEE LISA M. GOULEMAS 2002 FAMILY TRUST LISA M. GOULEMAS, TRUSTEE	5784/2715		PLAN OF LAND FOR NC WEN NEW CASTLE, N.H., REVISED	TO 8/14/2000, RCRD	PLAN C-28285.
7	5 SAGAMORE GROVE, PORTSMOUTH, NH 03801 BRIAN L. NESTE BRADFORD J. BYRD 184 WALKER BUNGALOW, PORTSMOUTH, NH 03801	5222/1547		LAND IN PORTSMOUTH, N.H., DATED 7/1954, RCRD PLAN PLAN OF LAND, PORTSMOUTH DATED 6/1950, FILE NO. 109	02283. H, N.H., SADIE P. GOUS	E TO JOHN S. DIMOCK,
8	WALTER J. ALLEN 1 SAGAMORE GROVE, PORTSMOUTH, NH 03801	2296/878	5.	NOT RECORDED. PLAN OF LAND, PORTSMOUTH		
12	SEA LEVEL, LLC PO BOX 4094, PORTSMOUTH, NH 03802-4094	5743/352	6	OSTERMAN, DATED 3/1946, F BY JOHN W. DURGIN, CE, NO PLAN OF LAND FOR MICHAEL	T RECORDED.	
22	WENTWORTH-SAGAMORE, LLC 1150 SAGAMORE AVE, PORTSMOUTH, NH 03801			PLAN OF LAND FOR MICHAEL PORTSMOUTH/RYE, NH, DATE RIGHT OF WAY PLAT, SAGAM	D 3/25/1999, RCRD P	LAN D-27320.
26	CITY OF PORTSMOUTH C/O CONSERVATION COMMISSION 1 JUNKINS AVE, PORTSMOUTH, NH 03801		8.	PORTSMOUTH, N.H., DATED 4 SUBDIVISION PLAN, TAX MAP	/9/1995, RCRD PLAN	D-25616.
25 5-A	SEACOAST MENTAL HEALTH CENTER 1145 SAGAMORE AVE, PORTSMOUTH, NH 03801 SEACOAST MENTAL HEALTH CENTER			TRUST, 955 SAGAMORE AVEN RCRD PLAN D-39767.		
5–B	1145 SAGAMORE AVE, PORTSMOUTH, NH 03801 CITY OF PORTSMOUTH 1 JUNKINS AVE, PORTSMOUTH, NH 03801		9.		SSELIN, TRUSTEE, 960	GOLDEN EGG, GOSSELIN SAGAMORE AVENUE, PORTSMOUTH, THE WRIGHT CHOICE, NOT RECORDED.
19	JUSTIN P. NADEAU & MICHELLE FIRMBACH NADEAU 507 STATE ST, PORTSMOUTH, NH 03801					


	LEGEND:			NOTES:
a	 ∞∞		1.	OWNER OF RECORD
	•IRON ROD SET			DEED REFERENCE
	 IRON PIPE FOUND BOUND as DESCRIBED 			TRUSTEES ARMAND E. GOSSELIN FRANCES M. GOSSELIN
	●DRILL HOLE PSNHPUBLIC SERVICE CO. OF NH			PARCEL AREA
r	VZVERIZON			ZONED
	10–5 TAX SHEET – LOT NUMBER			OWNER OF RECORD WENTWORTH CORNER, LLC ADDRESS
	(A)SEE SIGN TABLE			DEED REFERENCE
	CRDROCKINGHAM COUNTY REGISTRY OF DEEDS			PARCEL AREA
	ETWEDGE OF TRAVELLED WAY			ZONED
	VGCVERTICAL FACED GRANITE CURB			OWNER OF RECORD WENTWORTH CORNER, LLC ADDRESS
	⊕BOLLARD IIREFLECTOR			DEED REFERENCE
				PARCEL AREA
	DOUBLE POST SIGN			ZONED
	ØUTILITY POLE ØUTILITY POLE W∕TRANSFORMER			OWNER OF RECORD WENTWORTH CORNER, LLC ADDRESS
	¢LIGHT POLE			DEED REFERENCE
	OOUTILITY POLE WITH ARM & LIGHT			PARCEL AREA
	-• EELECTRIC METER			ZONED
	OVERTICAL PROPANE TANK		2.	ZONED: MRB FRONT YARD SETBACK5' MINIMUM LOT AREA 7,500 S.F. SIDE YARD SETBACK10'
C	O) HORIZONTAL PROPANE TANK			FRONTAGE100'REAR YARD SETBACK15'ZONED:WBFRONT YARD SETBACK30'
	►WATER GATE VALVE			MINIMUM LOT AREA 20,000 S.F. SIDE YARD SETBACK30'
	المعنى HYDRANT		3	FRONTAGE 100' REAR YARD SETBACK20' THE RELATIVE ERROR OF CLOSURE WAS LESS THAN 1 FOOT IN 15,000 FEET.
	IIICATCH BASIN			
\frown	·····.TREE LINE/BRUSH LINE		4.	THE LOCATION OF ALL UNDERGROUND UTILITIES SHOWN HEREON ARE APPROXIMATE AND ARE BASED UPON THE FIELD LOCATION OF ALL VISIBLE
_	- w —			STRUCTURES (IE CATCH BASINS, MANHOLES, WATER GATES ETC.) AND INFORMATIC COMPILED FROM PLANS PROVIDED BY UTILITY COMPANIES AND GOVERNMENTAL
	– <i>D</i> — <i>DRAIN</i> LINE			AGENCIES. ALL CONTRACTORS SHOULD NOTIFY, IN WRITING, SAID AGENCIES PRIOR TO ANY EXCAVATION WORK AND CALL DIG-SAFE @ 1-888-DIG-SAFE.
	-UGU—UNDERGROUND UTILITIES -OHW—OVERHEAD WIRES		5.	ON SITE CONTROL ESTABLISHED USING SURVEY GRADE GPS UNITS.
	CEMENT CONCRETE			HORIZONTAL DATUM: NAD 1983 (2011) VERTICAL DATUM: NAVD 1988
	RIP RAP			PRIMARY BM: CITY CONTROL POINT "ALBA"
	EXPOSED ROCK/LEDGE		6.	WETLANDS DELINEATION 12/2015 & 11/2019 BY MICHAEL CUOMO, NHCWS# 4, 6 YORK POND RD, YORK, ME 03909.
	<12.5SPOT GRADE		7.	LOCATION OF "WARRANT HIGHWAY EASEMENT" PER RCRD BOOK 3123, PAGE 2896
,	©BORING			DATED OCTOBER 18, 1995 & SHOWN ON "PLAN OF WENTWORTH ROAD (ROUTE 1–B), PORTSMOUTH, HIGHWAY EASEMENT". SAID PLAN IS NOT RECORDED
	A SEE SIGNAGE TABLE			& CAN NOT BE LOCATED BY NHDOT. SEE SAID DEED FOR OTHER RIGHTS GRANTED TO THE STATE OF NH.
	(A)SEE BUILDING ELEVATION TABLE		8.	THE SUBJECT TRACT LIES IN ZONE X (UNSHADED), AREAS DETERMINED TO BE OUTSIDE THE 0.2% ANNUAL CHANCE FLOODPLAIN, AS SHOWN ON FLOOD INSURANC
				RATE MAP NO. 33015C0286E, EFFECTIVE DATE MAY 17, 2005, BY FEMA.
			9.	THIS PLAN IS BASED ON A FIELD SURVEY 2016 & 2020 BY JAMES VERRA AND ASSOCIATES, INC.
	ABUTTERS LIST		10.	SAGAMORE GROVE ROAD IS A PUBLIC WAY. THE UNDERLYING FEE OF THIS PORTIC
				OF THE ROAD REMAINS WITH FRANCES & ARMAND GOSSELIN, THEIR HEIRS, SUCCE ASSIGNS. SEE ACKNOWLEDGEMENT & RELEASE DATED 3/17/1997, RCRD BOOK 32
MAP-LOT	OWNER OF RECORD	DEED REF.	11.	CONTRACTOR TO VERIFY SITE BENCHMARKS BY LEVELING BETWEEN 2
201-1	955 SAGAMORE REALTY TRUST – 3/12/2008 MICHAEL T. GOODRIDGE, TRUSTEE 39 FERRY RD, SALISBURY, MA 01952	4903/695		BENCHMARKS PRIOR TO THE SETTING OR ESTABLISHMENT OF ANY GRADES/ELEVA DISCREPANCIES ARE TO BE REPORTED TO JAMES VERRA AND ASSOC., INC.
201-1-1	WILLIAM L. PINGREE 11 SAGAMORE GROVE, PORTSMOUTH, NH 03801	5796/1142		REFERENCE PLANS:
201-3	LUCIAN SZMYD & DIANE M. SZMYD	4547/2733	1	PLAN OF LAND, 1150 SAGAMORE AVENUE, PORTSMOUTH, N.H.,
	41 HARBORVIEW DR, RYE, NH 03870	,	1.	RYE CORNER GAS, LLC, DATED 4/8/2015, RCRD PLAN C-38865.
201–6	JASON GOULEMAS 2002 FAMILY TRUST JASON GOULEMAS, TRUSTEE	5784/2715	2.	PLAN OF LAND FOR NC WENTWORTH, LLC, WENTWORTH ROAD, NEW CASTLE, N.H., REVISED TO 8/14/2000, RCRD PLAN C-28285.
	LISA M. GOULEMAS 2002 FAMILY TRUST LISA M. GOULEMAS, TRUSTEE		7	LAND IN PORTSMOUTH, N.H., SADIE P. GOUSE TO FRANCES L. PENDERGAST,
	5 SAGAMORE GROVE, PORTSMOUTH, NH 03801		5.	DATED 7/1954, RCRD PLAN 02283.
201-7	BRIAN L. NESTE BRADFORD J. BYRD	5222/1547	4.	PLAN OF LAND, PORTSMOUTH, N.H., SADIE P. GOUSE TO JOHN S. DIMOCK, DATED 6/1950, FILE NO. 109, PLAN NO. 1–420, BY JOHN W. DURGIN, CE,
201 8	184 WALKER BUNGALOW, PORTSMOUTH, NH 03801 WALTER J. ALLEN	2296/878		NOT RECORDED.
201-8	1 SAGAMORE GROVE, PORTSMOUTH, NH 03801	2290/070	5.	PLAN OF LAND, PORTSMOUTH, N.H., SADIE P. GOUSE TO LEONARD & EMILY OSTERMAN, DATED 3/1946, FILE NO. 109, PLAN NO. 1–295,
201-12	SEA LEVEL, LLC PO BOX 4094, PORTSMOUTH, NH 03802-4094	5743/352		BY JOHN W. DURGIN, CE, NOT RECORDED.
201-22	WENTWORTH-SAGAMORE, LLC		6.	PLAN OF LAND FOR MICHAEL KUCHTEY REVOCABLE TRUST, WENTWORTH ROAD,
	1150 SAGAMORE AVE, PORTSMOUTH, NH 03801		7	PORTSMOUTH/RYE, NH, DATED 3/25/1999, RCRD PLAN D-27320. RIGHT OF WAY PLAT, SAGAMORE GROVE, PORTSMOUTH, N.H. FOR CITY OF
201-26	CITY OF PORTSMOUTH C/O CONSERVATION COMMISSION 1 JUNKINS AVE, PORTSMOUTH, NH 03801		0	PORTSMOUTH, N.H., DATED 4/9/1995, RCRD PLAN D-25616.
223-25	SEACOAST MENTAL HEALTH CENTER 1145 SAGAMORE AVE, PORTSMOUTH, NH 03801		δ.	SUBDIVISION PLAN, TAX MAP 201 – LOT 1, OWNER: 955 SAGAMORE REALTY TRUST, 955 SAGAMORE AVENUE, PORTSMOUTH, N.H., REVISED TO 6/29/2016, RCRD PLAN D-39767.
223-25-A	SEACOAST MENTAL HEALTH CENTER 1145 SAGAMORE AVE, PORTSMOUTH, NH 03801		9.	SUBSURFACE SEWAGE DISPOSAL SYSTEM FOR THE GOLDEN EGG, GOSSELIN
223-25-B	CITY OF PORTSMOUTH 1 JUNKINS AVE, PORTSMOUTH, NH 03801			LIVING TRUST / THOMAS GOSSELIN, TRUSTEE, 960 SAGAMORE AVENUE, PORTSMOUNNH, JOB # 11-0136, REVISED TO $10/22/2011$, BY THE WRIGHT CHOICE, NOT RECO
224-19	JUSTIN P. NADEAU & MICHELLE FIRMBACH NADEAU			
	507 STATE ST, PORTSMOUTH, NH 03801			


SEE SHEETS 2 & 3 FOR PLANIMETRIC INFORMATION

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	SURVEYOR:
	James Verra and
	Associates, Inc.
	·
	LAND SURVEYORS
	101 SHATTUCK WAY – SUITE 8
	NEWINGTON, N.H. 03801- 7876
	603-436-3557 JOB NO: 23655
	PLAN NO: 23655-2
	ENGINEER:
	ENGINEERING, INC.
	,
	133 COURT STREET PORTSMOUTH, NH 03801
	(603) 433–2335 www.ALTUS–ENG.com
	ISSUED FOR:
	ENGINEERING DESIGN
	ISSUE DATE:
	FEBRUARY 20, 2020
	REVISIONS NO. DESCRIPTIONBYDATE
	NO. DESCRIPTIONBYDATE1ENGINEERING DESIGNJV2/20/20
	DRAWN BY:JCS
	APPROVED BY:JV
	DRAWING FILE: 23655-2.DWG
	SCALE:
	$22" \times 34" - 1" = 20'$
	$11" \times 17" - 1" = 40'$
	APPLICANT:
	OWNERS:
	OWNERS: GOSSELIN LIVING TRUST
	GOSSELIN LIVING TRUST ARMAND E. GOSSELIN, TR
	GOSSELIN LIVING TRUST ARMAND E. GOSSELIN, TR FRANCES M. GOSSELIN, TR.
	GOSSELIN LIVING TRUST ARMAND E. GOSSELIN, TR FRANCES M. GOSSELIN, TR. 960 SAGAMORE AVENUE
	GOSSELIN LIVING TRUST ARMAND E. GOSSELIN, TR FRANCES M. GOSSELIN, TR. 960 SAGAMORE AVENUE PORTSMOUTH, NH 03801 DEED REF: 3469/2151
	GOSSELIN LIVING TRUST ARMAND E. GOSSELIN, TR FRANCES M. GOSSELIN, TR. 960 SAGAMORE AVENUE PORTSMOUTH, NH 03801
	GOSSELIN LIVING TRUST ARMAND E. GOSSELIN, TR FRANCES M. GOSSELIN, TR. 960 SAGAMORE AVENUE PORTSMOUTH, NH 03801 DEED REF: 3469/2151 ASSESSOR'S PARCEL 201-2 WENTWORTH CORNER, LLC
	GOSSELIN LIVING TRUST ARMAND E. GOSSELIN, TR FRANCES M. GOSSELIN, TR. 960 SAGAMORE AVENUE PORTSMOUTH, NH 03801 DEED REF: 3469/2151 ASSESSOR'S PARCEL 201-2 WENTWORTH CORNER, LLC 1150 SAGAMORE ROAD
	GOSSELIN LIVING TRUST ARMAND E. GOSSELIN, TR FRANCES M. GOSSELIN, TR. 960 SAGAMORE AVENUE PORTSMOUTH, NH 03801 DEED REF: 3469/2151 ASSESSOR'S PARCEL 201-2 WENTWORTH CORNER, LLC 1150 SAGAMORE ROAD PORTSMOUTH, NH 03801 DEED REF: 6045/1665
	GOSSELIN LIVING TRUST ARMAND E. GOSSELIN, TR FRANCES M. GOSSELIN, TR. 960 SAGAMORE AVENUE PORTSMOUTH, NH 03801 DEED REF: 3469/2151 ASSESSOR'S PARCEL 201-2 WENTWORTH CORNER, LLC 1150 SAGAMORE ROAD PORTSMOUTH, NH 03801
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	GOSSELIN LIVING TRUST ARMAND E. GOSSELIN, TR FRANCES M. GOSSELIN, TR. 960 SAGAMORE AVENUE PORTSMOUTH, NH 03801 DEED REF: 3469/2151 ASSESSOR'S PARCEL 201-2 WENTWORTH CORNER, LLC 1150 SAGAMORE ROAD PORTSMOUTH, NH 03801 DEED REF: 6045/1665 ASSESSOR'S PARCEL 201-9 WENTWORTH CORNER, LLC 1150 SAGAMORE ROAD PORTSMOUTH, NH 03801 DEED REF: 6045/1667
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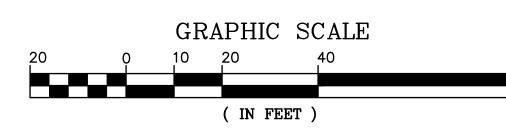


DEMOLITION NOTES

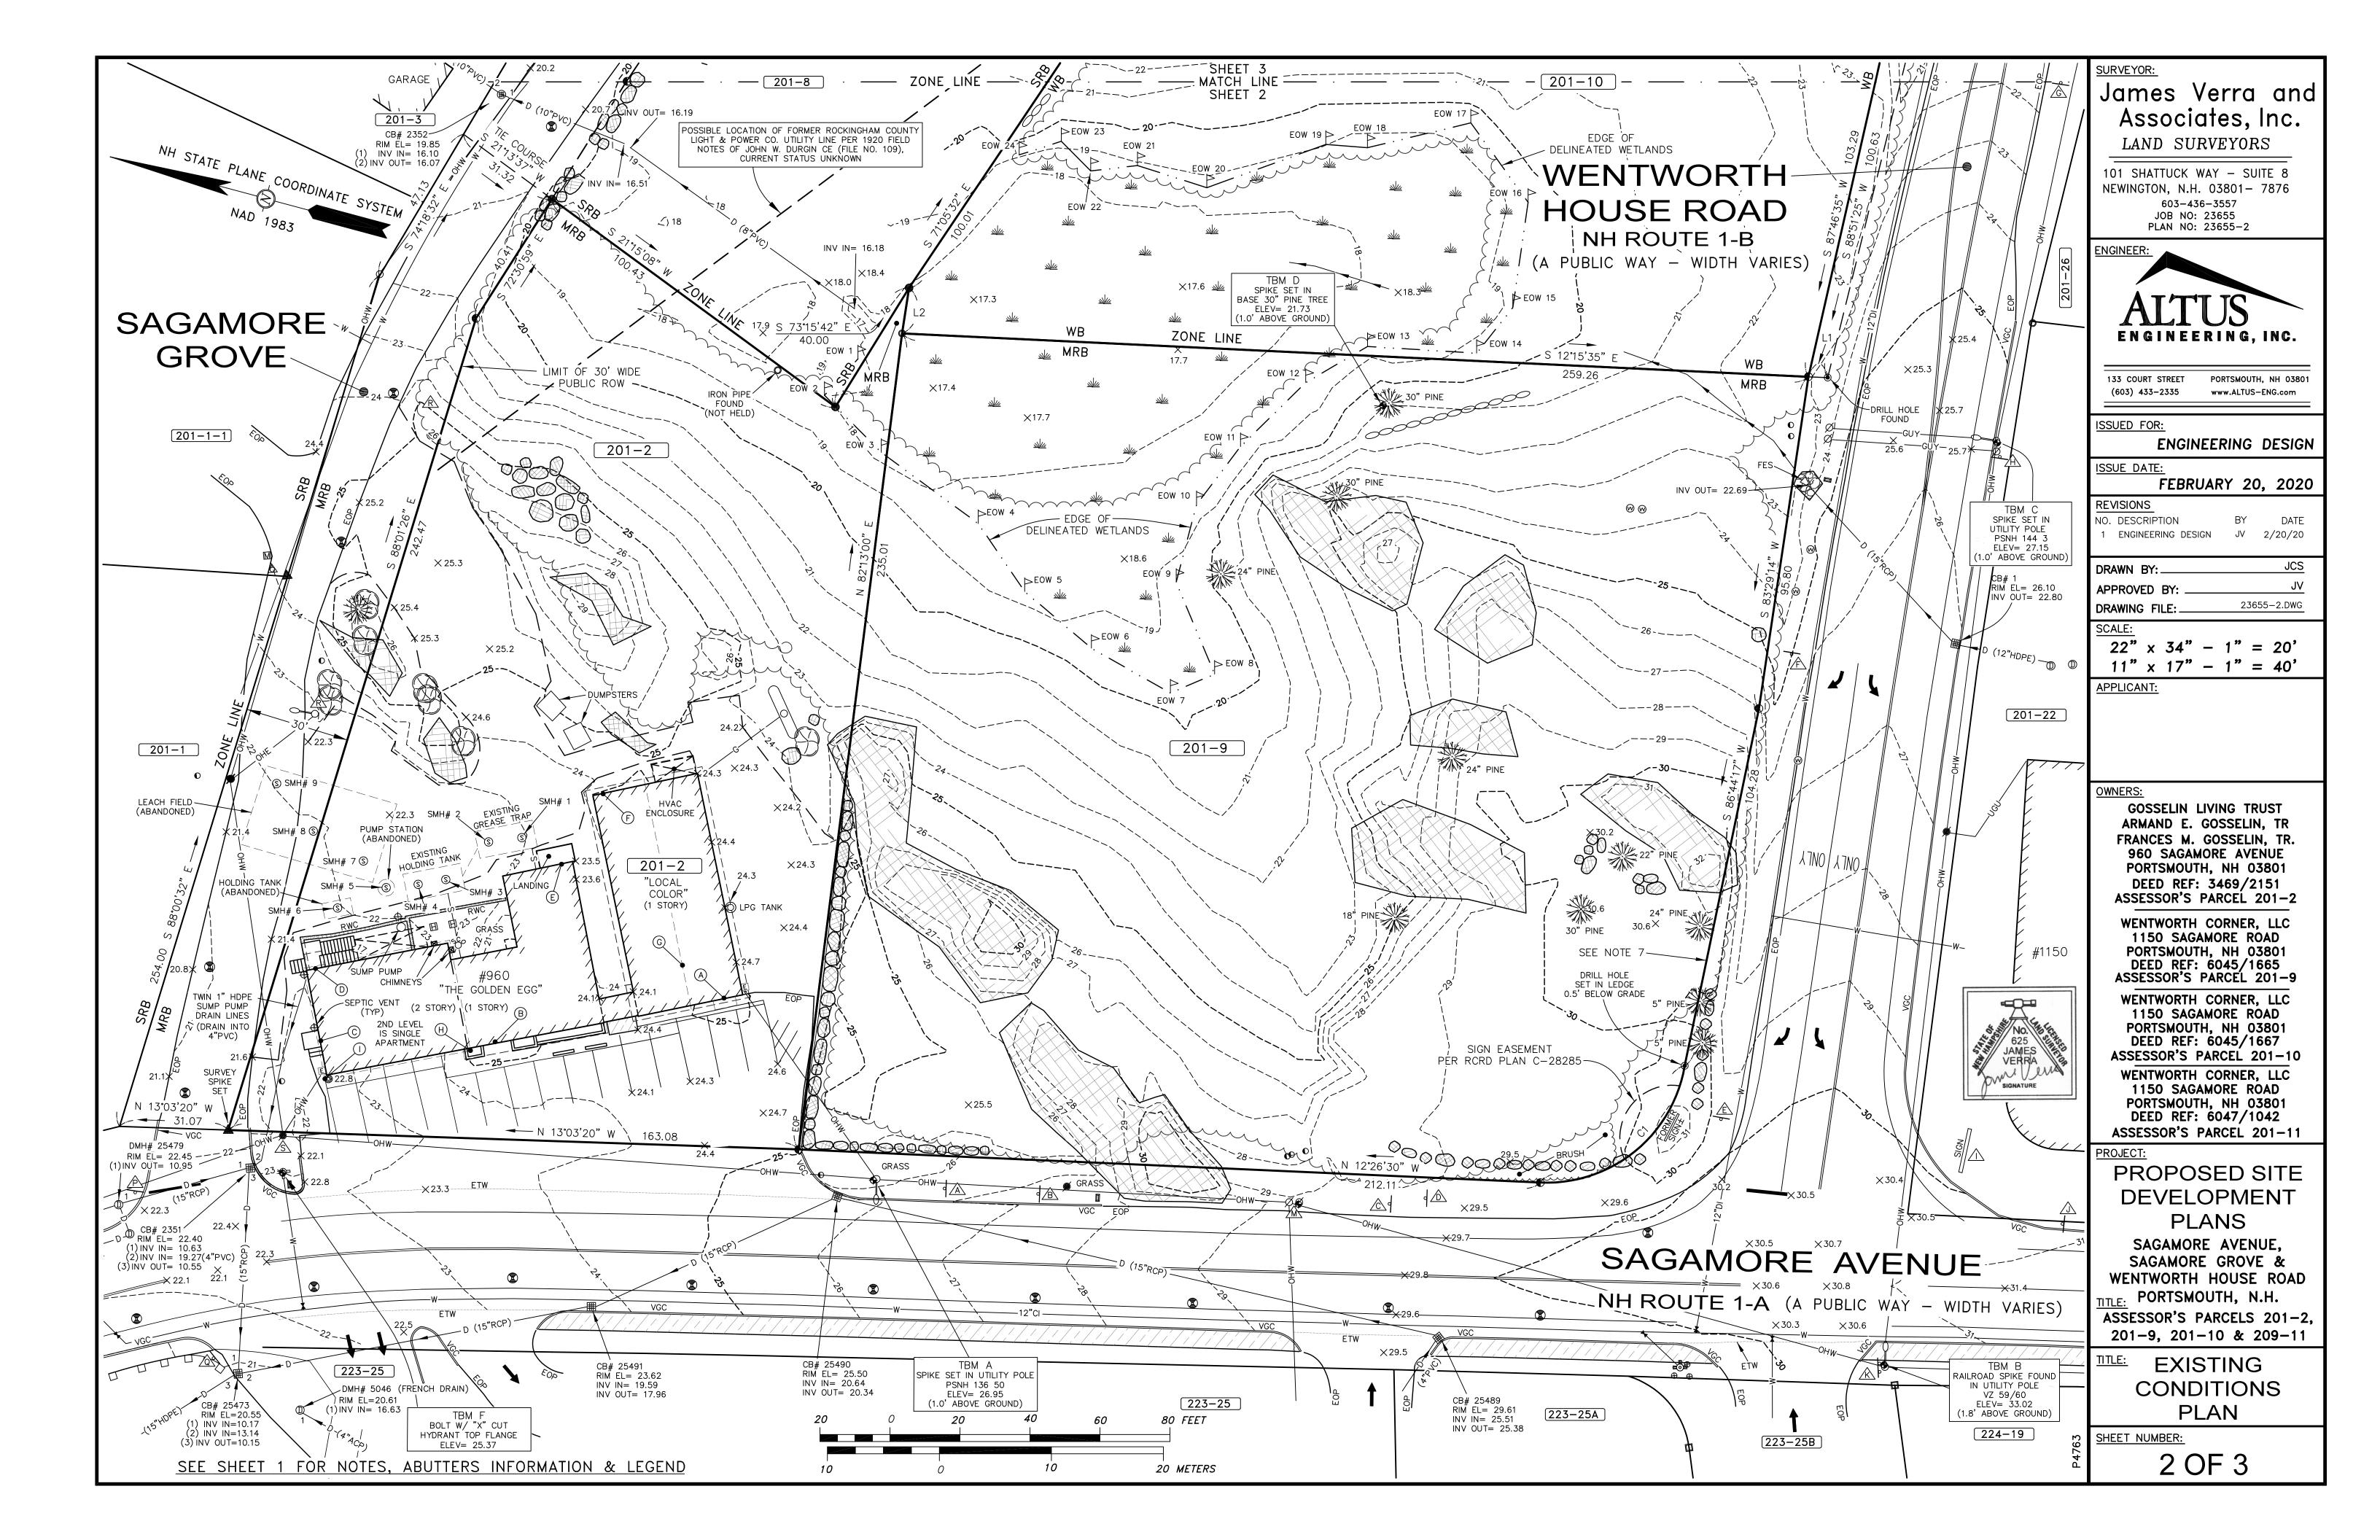- HOURS.
- PROCESS MAY REQUIRE A 30-DAY LEAD TIME.
- 3. CONTRACTOR SHALL PRESERVE AND PROTECT ALL EXISTING UTILITIES SCHEDULED TO REMAIN.
- CONSTRUCT THE PROJECT.
- UTILITIES ARE SUBJECT TO DEMOLITION, RELOCATION, MODIFICATION AND/OR CONSTRUCTION.
- THE CONTRACTOR SHALL BE RESPONSIBLE FOR ALL RELATED EXCAVATION, TRENCHING AND BACKFILLING.
- PURPOSES AND MEETING THE PROJECT SPECIFICATIONS.
- ETC. SHALL BE ADJUSTED TO FINISH GRADE.
- 9. NO BURNING SHALL BE PERMITTED PER LOCAL REGULATIONS.
- 11. IN AREAS WHERE CONSTRUCTION IS TO BE ADJACENT TO ABUTTING PROPERTIES, THE CONTRACTOR SHALL INSTALL ORANGE CONSTRUCTION FENCING ALONG THE PROPERTY LINE IN ALL AREAS WHERE SILT FENCING IS NOT OTHERWISE REQUIRED.
- 12. SEE EROSION CONTROL PLANS FOR EROSION CONTROL REQUIREMENTS TO BE IN PLACE PRIOR TO START OF AND STORM DRAIN INLET PROTECTION.
- CONTRACTOR UNLESS SPECIFIED.
- & FEDERAL REGULATIONS AND CODES.
- WITH. SEE BEST MANAGEMENT PRACTICES FOR BLASTING NOTES.

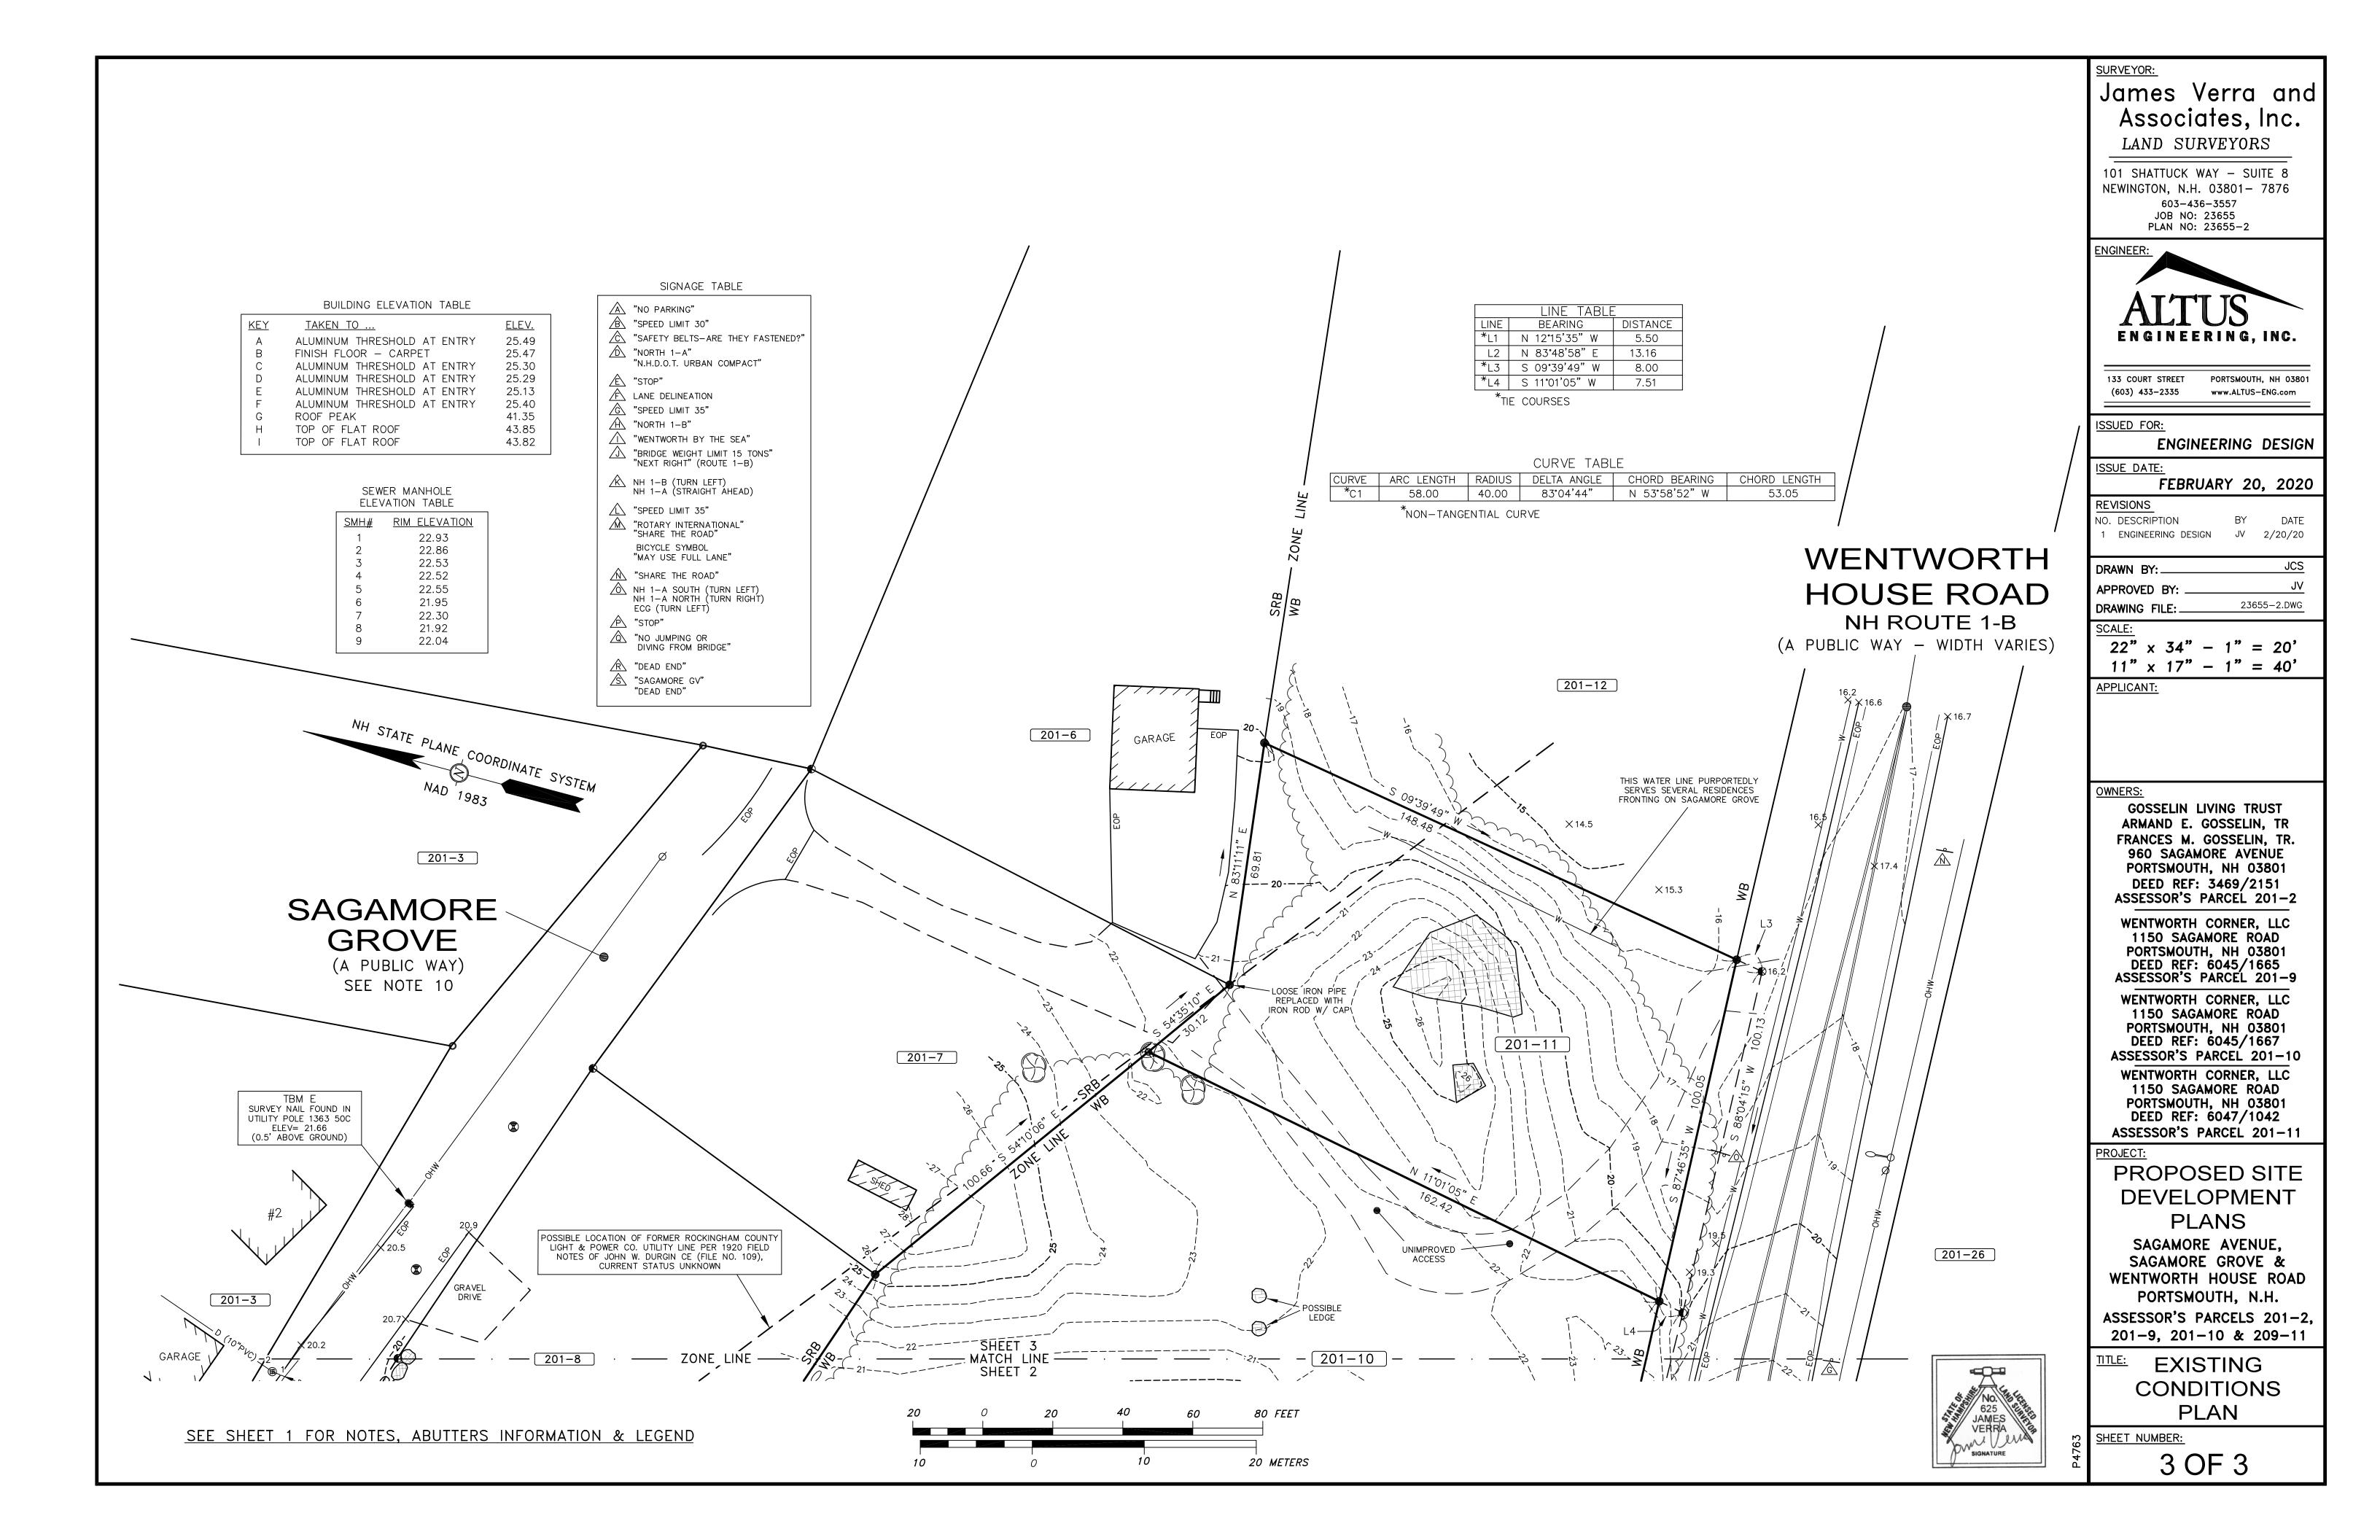UTILITY CONTACTS:

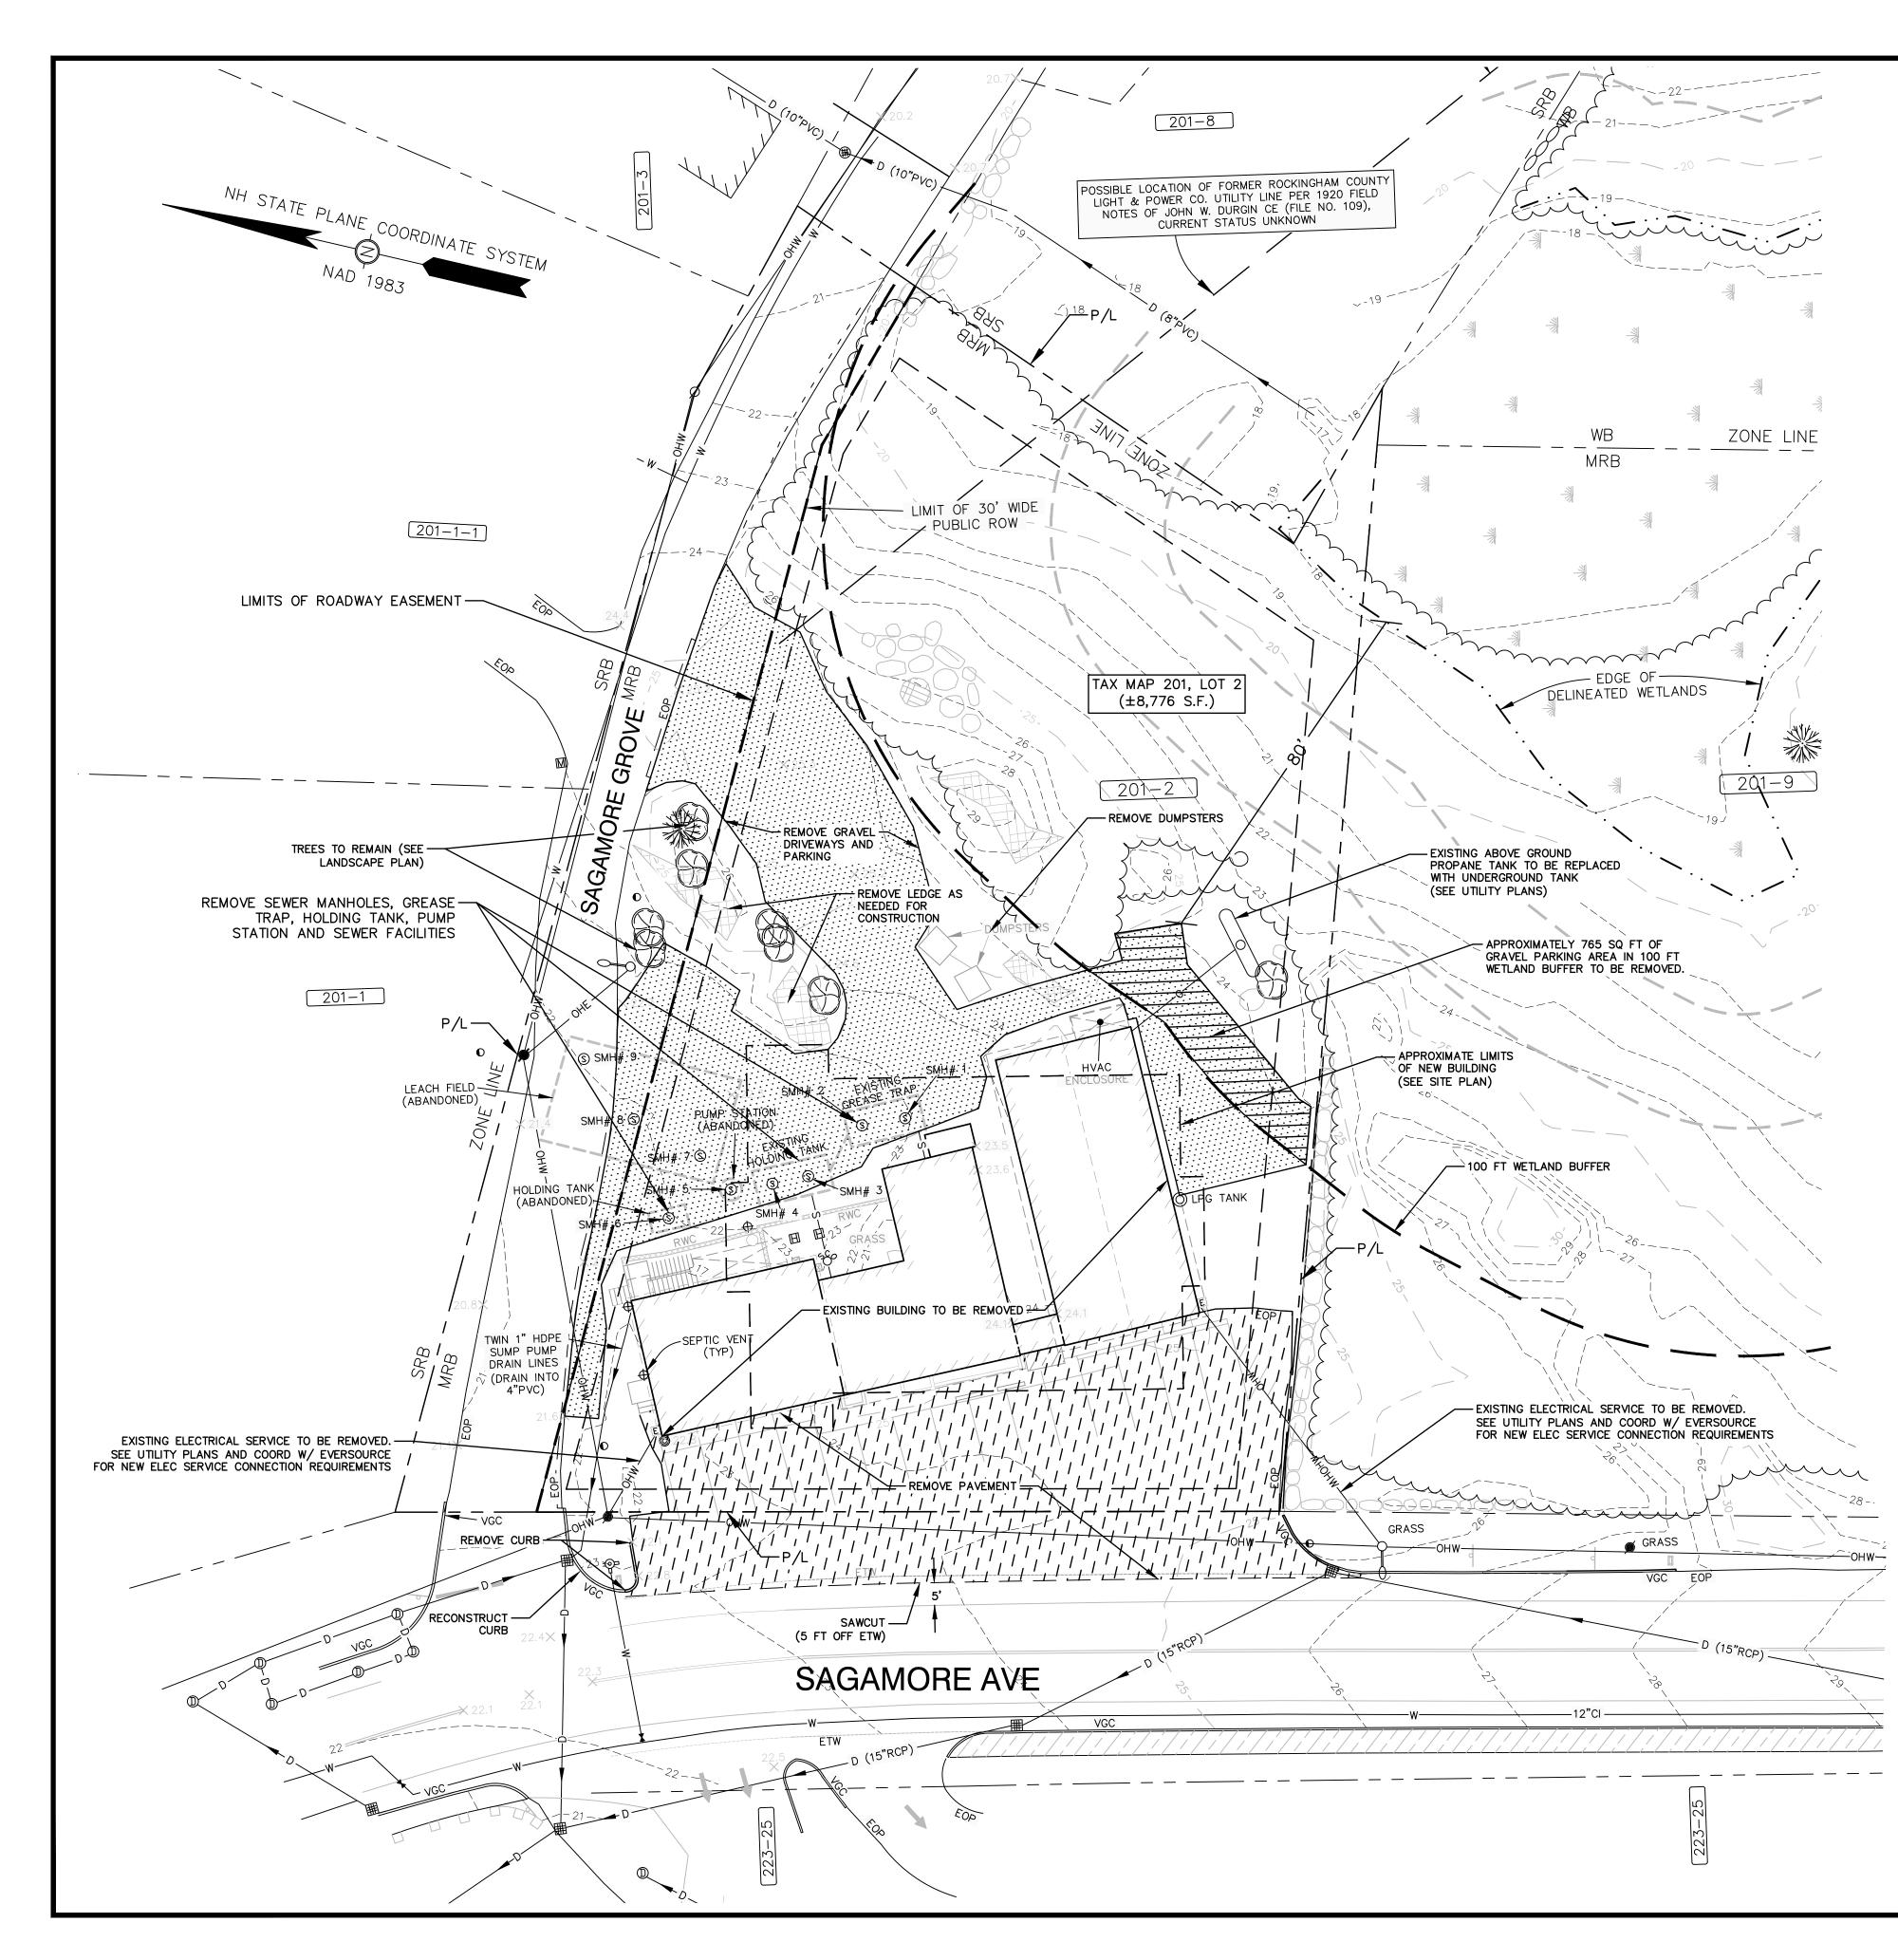- 16. CONTRACTOR SHALL COORDINATE ALL ELECTRICAL DISCONNECTIONS/INSTALLATIONS WITH EVERSOURCE. CONTACT NICK KOSKO @ 603-332-4227, EXT. 5555334
- 17. CONTRACTOR SHALL COORDINATE ALL NATURAL GAS DISCONNECTIONS/INSTALLATIONS WITH UNITIL CORPORATION. CONTACT DAVID BEAULIEU @ 603-294-5144
- 18. CONTRACTOR SHALL COORDINATE ALL CABLE DISCONNECTIONS/INSTALLATIONS WITH COMCAST. CONTACT MIKE COLLINS @ 603-679-5695 EXT 1037
- 19. CONTRACTOR SHALL COORDINATE ALL TELE-COMMUNICATION DISCONNECTIONS AND INSTALLATION WITH FAIRPOINT COMMUNICATIONS. CONTACT JOE CONSIONE @ 603-427-5255



APPROVED BY THE PORTSMOUTH PLANNING BOARD

CHAIRMAN

DATE



2. CITY DEMOLITION PERMIT REQUIRED PRIOR TO ANY DEMOLITION ACTIVITIES. CONTRACTOR IS NOTIFIED THAT THIS PERMIT

4. THIS DEMOLITION PLAN IS INTENDED TO PROVIDE MINIMUM GUIDELINES FOR THE DEMOLITION OF EXISTING SITE FEATURES. UNLESS OTHERWISE NOTED TO REMAIN, THE CONTRACTOR SHALL BE RESPONSIBLE FOR THE REMOVAL OF ALL PAVEMENT, CONCRETE, CURBING, SIGNS, POLES, UTILITIES, FENCES, VEGETATION AND OTHER EXISTING FEATURES AS NECESSARY TO FULLY

5. THE CONTRACTOR SHALL BE RESPONSIBLE FOR THE TIMELY NOTIFICATION OF ALL PARTIES, CORPORATIONS, COMPANIES, INDIVIDUALS AND STATE AND LOCAL AUTHORITIES OWNING AND/OR HAVING JURISDICTION OVER ANY UTILITIES RUNNING TO, THROUGH OR ACROSS AREAS TO BE DISTURBED BY DEMOLITION AND/OR CONSTRUCTION ACTIVITIES WHETHER OR NOT SAID

6. ALL UTILITY DISCONNECTIONS/DEMOLITIONS/RELOCATIONS TO BE COORDINATED BETWEEN THE CONTRACTOR, ALL APPROPRIATE UTILITY COMPANIES AND THE PORTSMOUTH DEPARTMENT OF PUBLIC WORKS. UNLESS OTHERWISE SPECIFIED,

7. ALL STRUCTURES, CURBING, CONCRETE, PAVEMENT AND SUBBASE MATERIALS SHALL BE REMOVED FROM PROPOSED LANDSCAPE AREAS AND REPLACED WITH LOAM MATERIALS SUITABLE FOR LANDSCAPE AND/OR STORMWATER MANAGEMENT

8. WHERE SPECIFIED TO REMAIN, MANHOLE RIMS, CATCH BASIN GRATES, VALVE COVERS, HANDHOLES, MONITORING WELLS,


10. HAZARDOUS MATERIALS ENCOUNTERED DURING DEMOLITION AND CONSTRUCTION ACTIVITIES SHALL BE ABATED IN STRICT ACCORDANCE WITH ALL APPLICABLE STATE AND LOCAL REGULATIONS.

DEMOLITION ACTIVITIES, INCLUDING, BUT NOT LIMITED TO; SILT FENCING, STABILIZED CONSTRUCTION SITE EXITS,

13. ALL DEMOLISHED MATERIALS OR MATERIALS SCHEDULED TO BE REMOVED SHALL BECOME THE PROPERTY OF THE

14. ALL MATERIALS SCHEDULED TO BE REMOVED SHALL BE LEGALLY DISPOSED IN ACCORDANCE WITH ALL LOCAL, STATE,

15. LEDGE REMOVAL IS ANTICIPATED ON THE PROJECT. THE CONTRACTOR SHALL PROVIDE THE CITY WITH A LEDGE REMOVAL PLAN. IF BLASTING IS TO BE PERFORMED, ALL STATE AND LOCAL REQUIREMENTS SHALL BE COMPLIED

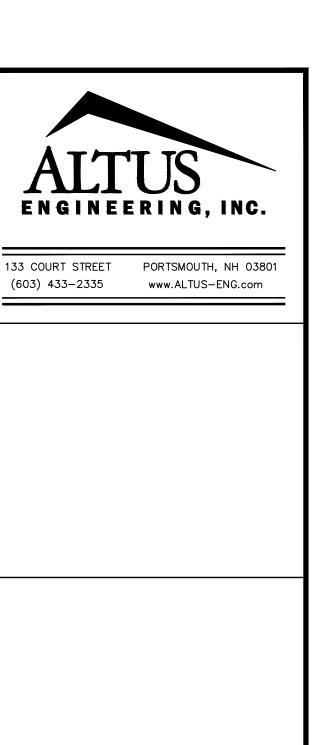

NOT FOR CONSTRUCTION

ISSUED FOR:	<u>.</u>			
	TAC	WORK	SE	SSION
ISSUE DATE:	<u>.</u>			
	NOV	EMBER	2,	2021
REVISIONS				
NO. DESCRIPT	ION		BY	DATE
0 INITIAL SU	BMITTAL		CDB	11/02/21

DRAWN BY: APPROVED BY: _ DRAWING FILE:

22"x34" 1" = 20' <u>SCALE:</u> $11" \times 17" 1" = 40'$

CDB

EDW

5079-SITE.dwg

OWNER:

WENTWORTH CORNER, LLC

1150 SAGAMORE AVENUE PORTSMOUTH, NH 03801

APPLICANT: KATZ DEVELOPMENT CORPORATION


> 273 CORPORATE DRIVE PORTSMOUTH, NH 03801

PROJECT: PROPOSED MULTI-FAMILY RESIDENTIAL DEVELOPMENT TAX MAP 201 LOT 2SAGAMORE ROAD PORTSMOUTH, NH 03801

<u>TITLE:</u>

DEMOLITION PLAN

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SIGN INTENT – THIS PLAN IS IN SIDENTIAL BUILDING TOGETHER W	
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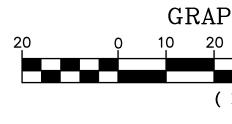
- 5. DIMENSIONAL REQUIREMENTS:

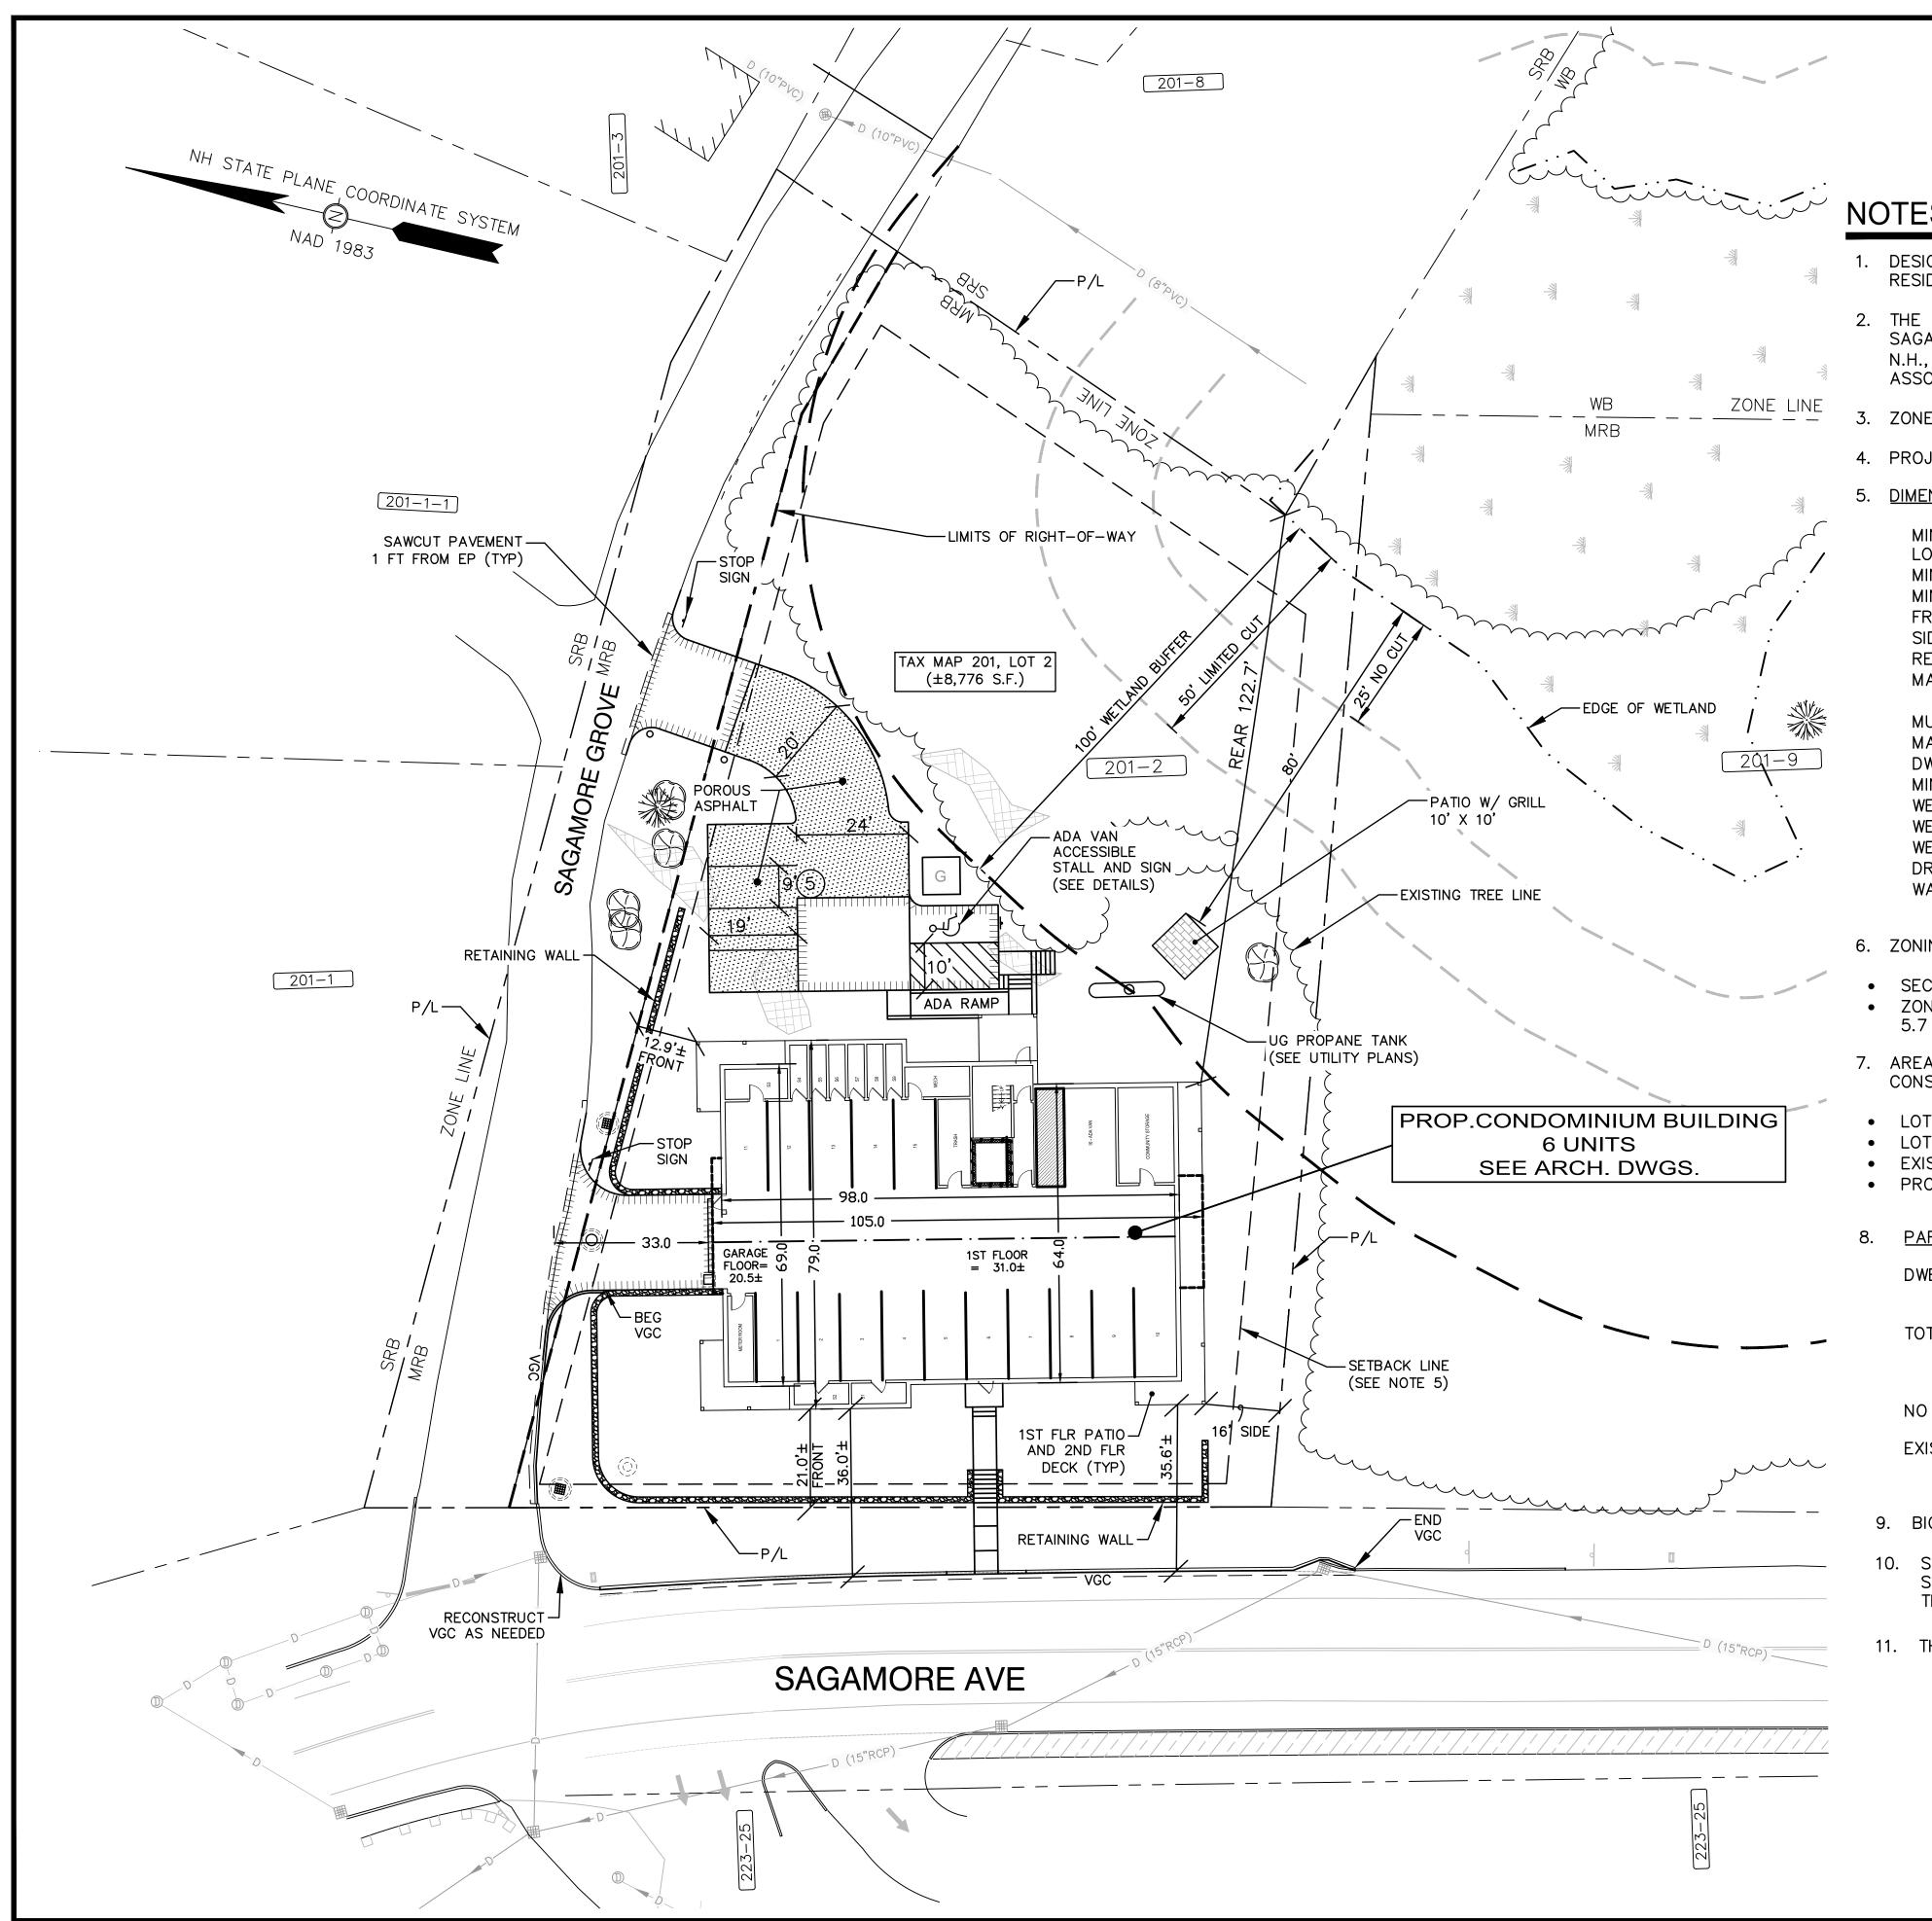
MIN. LOT AREA: LOT AREA PER DWELLING:	7, 7,
MIN. STREET FRONTAGE:	10
MIN. LOT DEPTH:	80
FRONT SETBACK:	5'
SIDE SETBACK:	10
REAR SETBACK:	15
MAX. BUILDING HEIGHT:	40
	(±
MULTI-FAM. BLDG. LENGTH:	16
MAX. BUILDING COVERAGE:	40
DWELLING UNITS PER BLDG:	8
MIN. OPEN SPACE:	25
WETLAND BUFFER:	10
WETLAND LIMITED CUT:	50
WETLAND NO-CUT:	25
DRIVEWAY/RD/PARKING/BLDG:	±:
DRIVE WAT/RD/FARRING/DEDG.	، ــــ

- PARKING REQUIREMENTS: 8.

PROVED BY THE PORTSMOUTH PLANNING BOARD ENGINEERING, INC. CHAIRMAN DATE 133 COURT STREET PORTSMOUTH, NH 03801 (603) 433–2335 www.ALTUS–ENG.com DES ED TO DEPICT A CONCEPTUAL MULTI-FAMILY RES ASSOCIATED PARKING AND ACCESSWAYS. LOPED FROM "EXISTING CONDITIONS PLAN, SAGAMORE AVENUE, SAGAMORE GROVE & WENTWORTH HOUSE ROAD, PORTSMOUTH, N.H., ASSESSOR'S PARCELS 201-2, 201-9, 201-10 & 209-11" BY JAMES VERRA AND ASSOCIATES, INC., DATED FEBRUARY 20, 2020. ZONES: MRB (MIXED RESIDENTIAL BUSINESS) 42,930 S.F. (±0.99 AC.) 4. PROJECT PARCEL: TAX MAP 201 LOT 2 <u>PROVIDED</u> <u> MRB</u> 7,500 S.F. (0.17 AC.) 42,930 S.F. ±7,155 S.F. ,500 S.F. 00' ±194' ±212' ±21'& ±12' $(\pm 17' \text{ EXISTING})$ ±16' 0' (±21' EXISTING) ±122' 5' $(\pm 107' \text{ EXISTING})$ O' (SLOPED ROOF) <30' ±22' - EXISTING TWO STORIES) ±108' 60' (MAX) ±17.9% NOT FOR CONSTRUCTION 10% (±11% EXISTING) 6 (MAX) **ISSUED FOR:** 25% (±45.4% EXISTING) ±55.0% TAC WORK SESSION 00' (80' EXISTING) 80±' 50' ISSUE DATE: 25' NOVEMBER 2, 2021 ±52.2% (EXISTING) ±42.2% <u>REVISIONS</u> WALKS/OTHER: $\pm 2.4\%$ (EXISTING) ±2.0% NO. DESCRIPTION BY DATE 0 INITIAL SUBMITTAL CDB 11/02/2 6. ZONING - THE FOLLOWING TWO VARIANCES WERE GRANTED ON SEPTEMBER 21, 2021. SECTION 10.1114.31 - TO ALLOW TWO (2) DRIVEWAYS WHERE ONE (1) IS PERMITTED. • ZONING SECTION 10.521 - TO ALLOW A DENSITY OF SIX (6) DWELLING UNITS WHERE 5.7 ARE PERMITTED. CDB DRAWN BY:. 7. AREA OF DISTURBANCE UNDER 43,560 SF, COVERAGE UNDER EPA NPDES PHASE I EDW CONSTRUCTION GENERAL PERMIT NOT REQUIRED. APPROVED BY: _ 5079-SITE.dwg DRAWING FILE: • LOT AREA IN WETLAND: ± 400 S.F. ($\pm 0.9\%$) • LOT AREA IN WETLAND & WETLAND BUFFER: $\pm 13,650$ S.F. ($\pm 31.8\%$) <u>SCALE:</u> $22^{"}x34"1" = 20'$ • EXISTING LOT IMPERVIOUS IN WETLAND BUFFER: ± 760 S.F. ($\pm 1.8\%$) $11" \times 17" 1" = 40'$ • PROPOSED LOT IMPERVIOUS IN WETLAND BUFFER: ±438 S.F. (±1.1%) OWNER: WENTWORTH CORNER, LLC DWELLING UNITS: 1.3 SPACES PER DWELLING UNIT 1150 SAGAMORE AVENUE 6 UNITS x 1.3 = 7.8 SPACES REQUIRED PORTSMOUTH, NH 03801 16 SPACES (INTERIOR) APPLICANT: 5 SPACES (EXTERIOR) KATZ DEVELOPMENT 21 SPACES TOTAL CORPORATION NO MAXIMUM REQUIREMENT 273 CORPORATE DRIVE PORTSMOUTH, NH 03801 15 PAVED <u>11 GRAVEL (APPROX)</u> PROJECT: 26 TOTAL PROPOSED MULTI-FAMILY 9. BICYCLE PARKING WILL BE PROVIDED IN THE BASEMENT OF THE BUILDING. RESIDENTIAL DEVELOPMENT 10. SNOW SHALL BE STORED AT THE EDGE OF PAVEMENT, IN UPLAND AREAS SHOWN THEREON. IF ADEQUATE ON-SITE SNOW STORAGE IS NOT AVAILABLE, TAX MAP 201 THE SNOW SHALL BE REMOVED FROM THE SITE AND LEGALLY DISPOSED. LOT 2SAGAMORE ROAD PORTSMOUTH, NH 03801 11. THE PROPOSED LIGHTING SHALL BE DARK SKY FRIENDLY. <u>TITLE:</u> GRAPHIC SCALE SITE PLAN SHEET NUMBER: **C-2** (IN FEET)

- TOTAL PARKING PROVIDED:
- EXISTING PARKING SPACES:



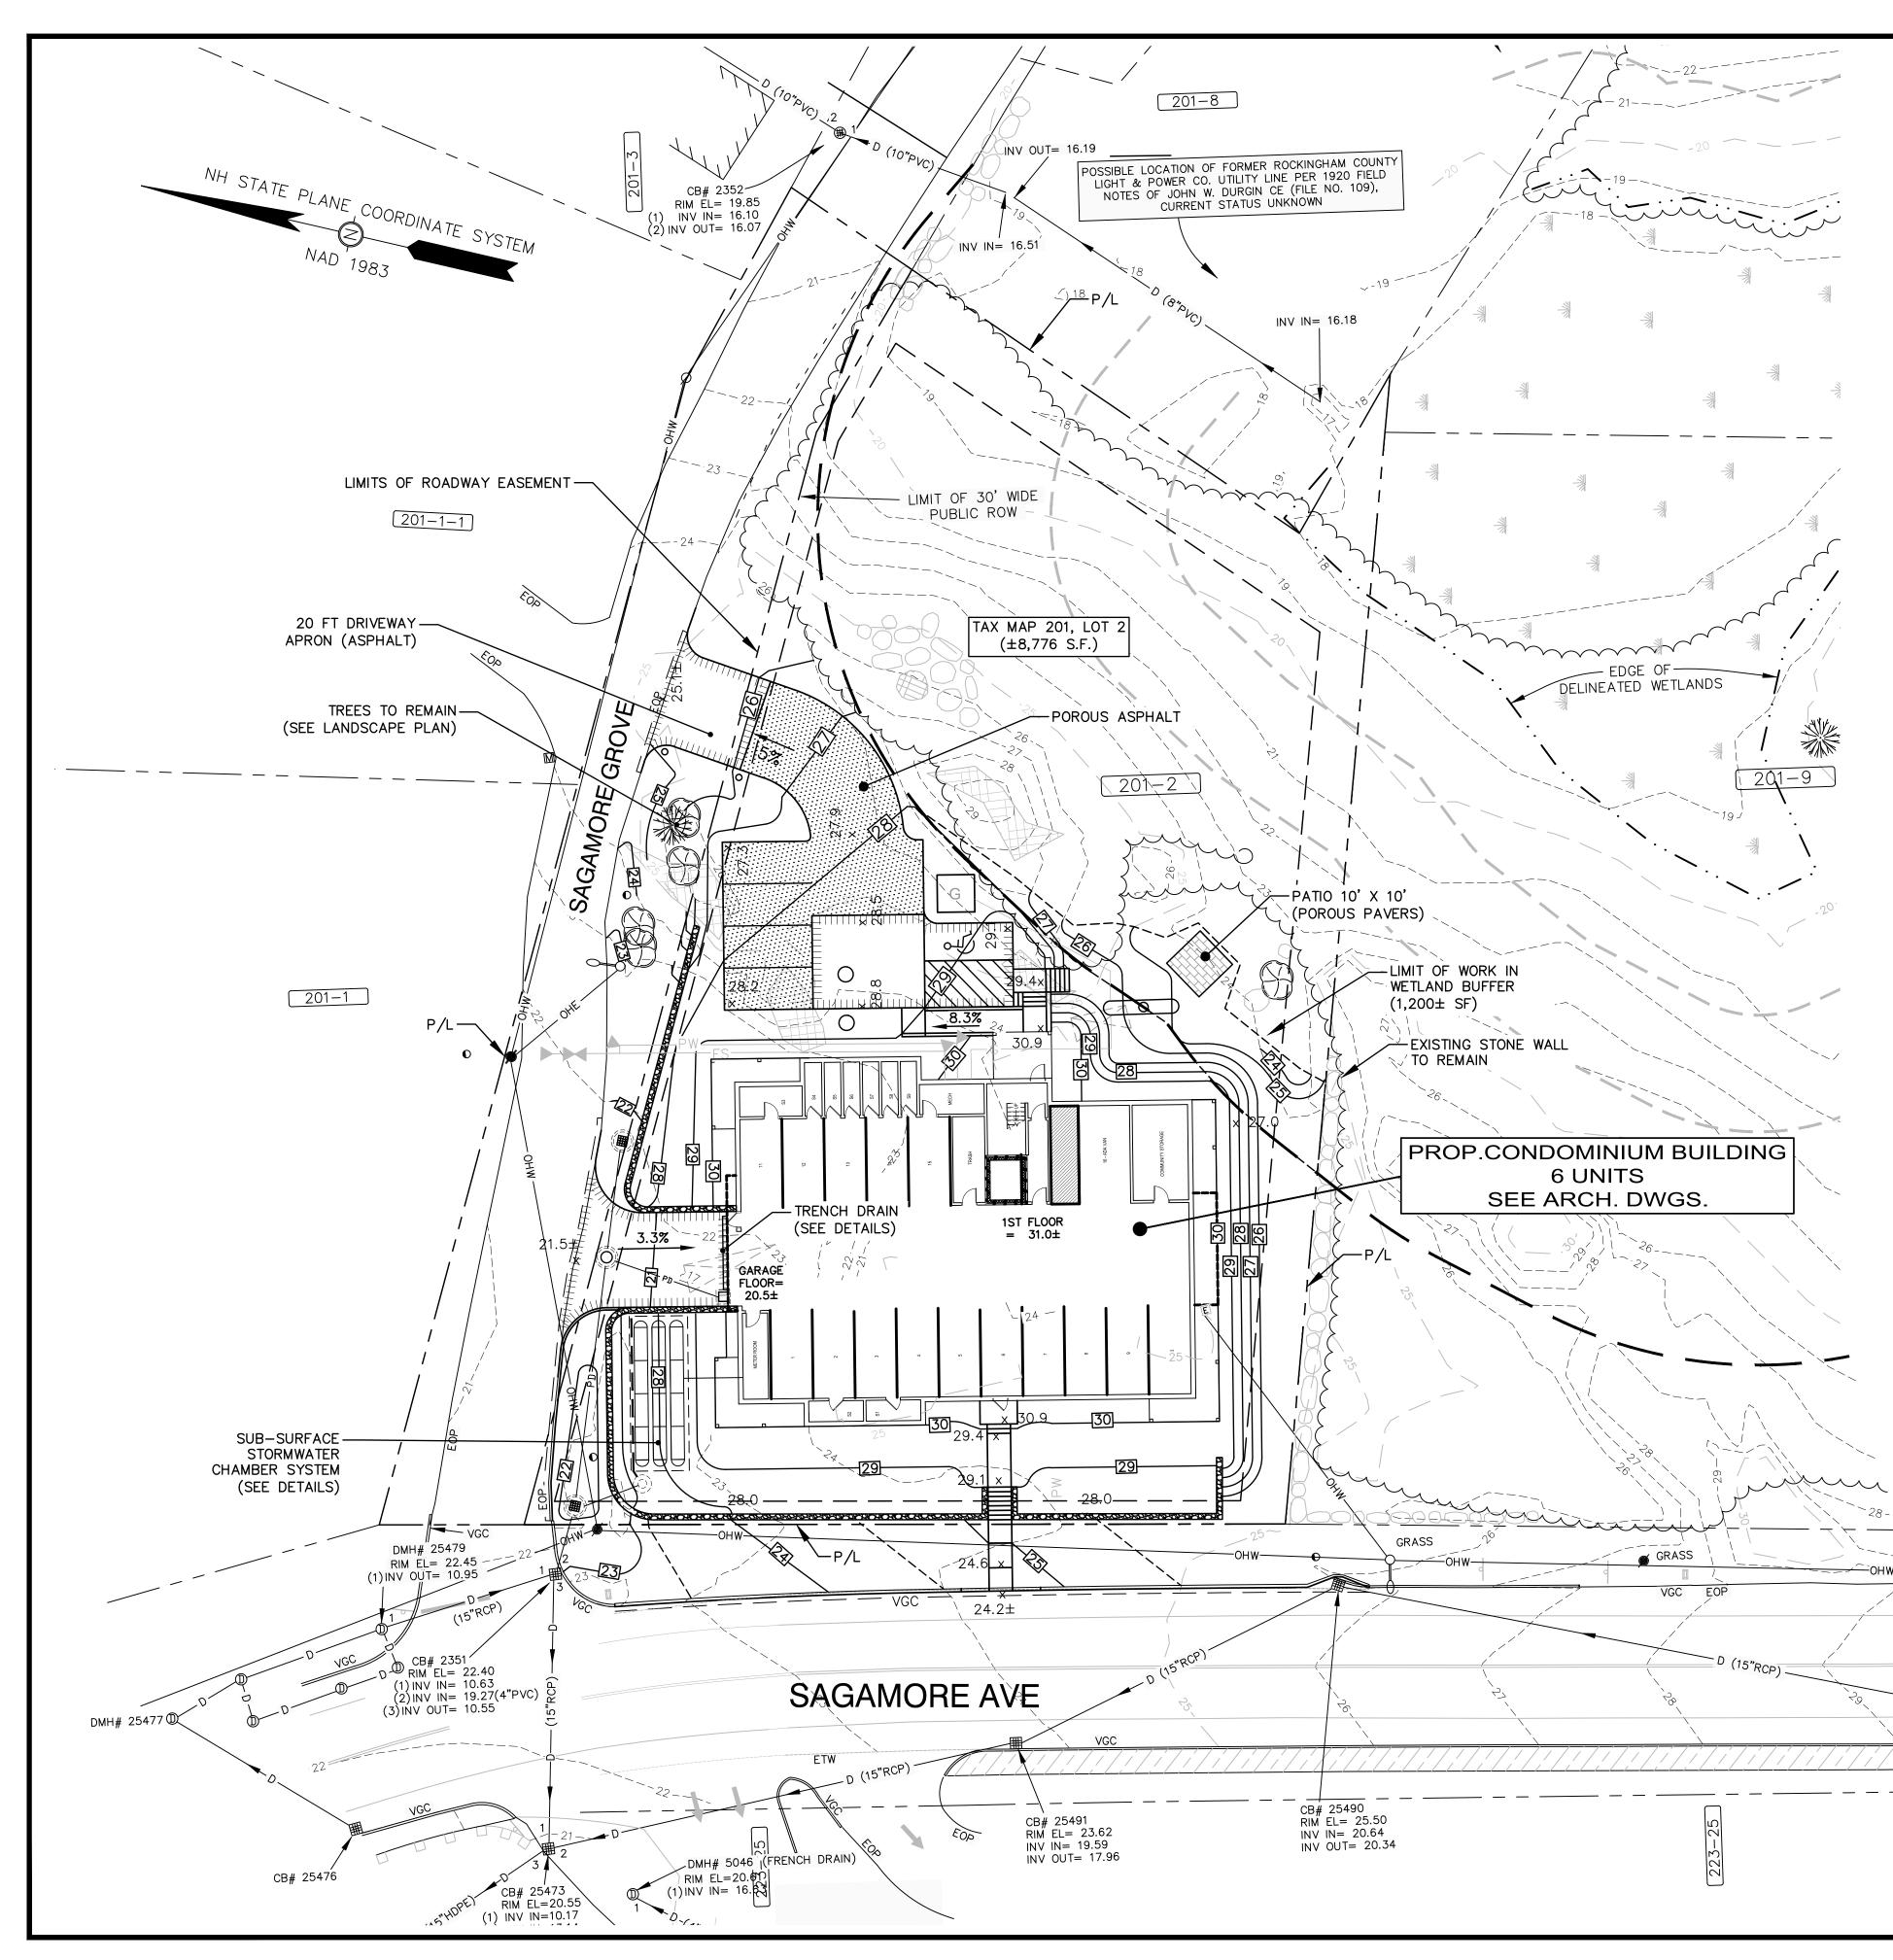




GRADING AND DRAINAGE NOTES

- 1. PRIOR TO CONSTRUCTION, CONTRACTOR SHALL FIELD VERIFY LOCATIONS AND ELEVATIONS OF ALL EXISTING UTILITIES SCHEDULED TO REMAIN.
- 3. PRIOR TO CONSTRUCTION, THE CONTRACTOR SHALL READ AND FAMILIARIZE THEMSELVES WITH THE PROJECT GEOTECHNICAL REPORT. THE CONTRACTOR SHALL BE RESPONSIBLE FOR FOLLOWING ALL THE RECOMMENDATIONS IN THE GEOTECHNICAL REPORT.
- 5. PROTECTION OF SUBGRADE: THE CONTRACTOR SHALL BE REQUIRED TO MAINTAIN STABLE, DEWATERED SUBGRADES FOR FOUNDATIONS, PAVEMENT AREAS, UTILITY TRENCHES AND OTHER AREAS DURING CONSTRUCTION. SUBGRADE OF EACH DAY'S OPERATIONS DEGREE OF INSULATION AGAINST FREEZING.
- PLACEMENT. FROZEN MATERIAL SHALL NOT BE USED FOR CONSTRUCTION.
- 7. ALL STORM DRAIN PIPE SHALL BE ADS N-12 OR EQUAL AND APPROVED BY THE ENGINEER.
- FINISHED GRADE. ANY RIM OR VALVE COVER ABOVE SURROUNDING FINISHED GRADE WILL NOT BE ACCEPTED.
- 9. ALL CATCH BASINS SHALL BE PRECAST, H-20 LOADING AND BE EQUIPPED WITH 4-FOOT DEEP MIN SEDIMENTATION SUMPS AND GREASE HOODS. (SEE DETAILS)
- 10. ALL SPOT GRADES ARE AT THE FINISH GRADE AND BOTTOM OF CURB WHERE APPLICABLE.
- DIRECTION OF THE ENGINEER.
- 12. MODULAR BLOCK RETAINING WALL FINISH TO BE SELECTED BY OWNER.
- 13. ALL INTERNAL FLOOR DRAINS SHALL BE EVAPORATIVE AND SHALL NOT TIE INTO EXTERNAL STORM DRAIN SYSTEM.
- 14. CONTRACTOR SHALL PROTECT ALL RAINGARDENS FROM CONSTRUCTION STORMWATER RUNOFF. TEMPORARY SEDIMENT UNTIL THE WATERSHED ARE HAS BEEN STABILIZED.

STORMWATER PRACTICES


SUB-SURFACE CHAMBER SYSTEM STORMTECH SC-310 (OR APPROVED EQUAL) 15 CHAMBERS TOTAL - 3 ROWS OF 4 EACH CHAMBER BOTTOM ELEV = 24.54" UNDERDRAIN INV = 23.75STORAGE VOLUME = 400 CF(CONTRACTOR TO COMPLY WITH MANUFACTURER RECOMMENDATIONS FOR INSTALLATION)

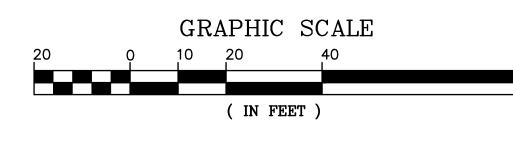

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CHAIRMAN

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2. ALL BENCHMARKS AND TOPOGRAPHY SHALL BE FIELD VERIFIED BY THE CONTRACTOR PRIOR TO INITIATING CONSTRUCTION

4. DEWATERING ACTIVITIES SHALL BE DONE IN ACCORDANCE WITH EPA AND NHDES REGULATIONS AND GUIDELINES.

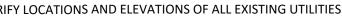
DISTURBANCE MAY BE INFLUENCED BY EXCAVATION METHODS, MOISTURE, PRECIPITATION, GROUNDWATER CONTROL, AND CONSTRUCTION ACTIVITIES. THE CONTRACTOR SHALL TAKE PRECAUTIONS TO PREVENT SUBGRADE DISTURBANCE. SUCH PRECAUTIONS MAY INCLUDE DIVERTING STORMWATER RUNOFF AWAY FROM CONSTRUCTION AREAS, REDUCING TRAFFIC IN SENSITIVE AREAS, AND MAINTAINING AN EFFECTIVE DEWATERING PROGRAM. SOILS EXHIBITING HEAVING OR INSTABILITY SHALL BE OVER EXCAVATED TO MORE COMPETENT BEARING SOIL AND BEARING SOIL AND REPLACED WITH FREE DRAINING STRUCTURAL FILL IF THE EARTHWORK IS PERFORMED DURING FREEZING WEATHER, EXPOSED SUBGRADES AREA SUSCEPTIBLE TO FROST. NO FILL OR UTILITIES SHALL BE PLACED ON FROZEN SOIL CRUST AT THE COMMENCEMENT

6. IF SUITABLE, EXCAVATED MATERIALS SHALL BE PLACED AS FILL WITHIN UPLAND AREAS ONLY AND SHALL NOT BE PLACED WITHIN WETLANDS. PLACEMENT OF BORROW MATERIALS SHALL BE PERFORMED IN A MANNER THAT PREVENTS LONG TERM DIFFERENTIAL SETTLEMENT. EXCESSIVELY WET MATERIALS SHALL BE STOCKPILED AND ALLOWED TO DRAIN BEFORE

8. ALL CATCH BASIN, GATE VALVE COVERS, AND MANHOLE RIMS SHALL BE SET FLUSH WITH OR NO LESS THAN 0.1' BELOW

11. UNLESS OTHERWISE SPECIFIED, RETAINING WALL AND BUILDING PERIMETER DRAINS SHALL BE DIRECTED TO THE NEAREST DRAINAGE STRUCTURE. IF DEEMED APPROPRIATE, CONTRACTOR SHALL PROVIDE ADDITIONAL UNDERDRAINS AT THE

BASINS SHALL BE CONSTRUCTED DURING CONSTRUCTION. STORMWATER SHALL NOT BE DIRECTED TO THE RAINGARDENS

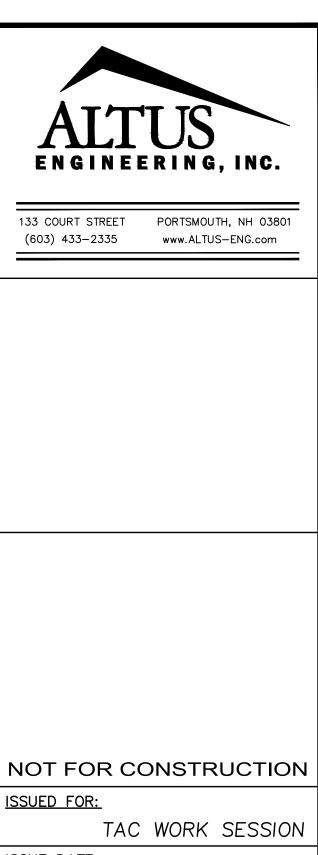

ISSUE DATE: NOVEMBER 2, 2021

<u>REVISIONS</u> NO. DESCRIPTION 0 INITIAL SUBMITTAL

BY DATE CDB 11/02/21

CDB

EDW

5079-SITE.dwg

DRAWN BY:. APPROVED BY: _ DRAWING FILE:

22"x34" 1" = 20' <u>SCALE:</u> $11" \times 17" 1" = 40'$

OWNER:

WENTWORTH CORNER, LLC

1150 SAGAMORE AVENUE PORTSMOUTH, NH 03801

APPLICANT: KATZ DEVELOPMENT CORPORATION


> 273 CORPORATE DRIVE PORTSMOUTH, NH 03801

PROJECT: PROPOSED MULTI-FAMILY RESIDENTIAL DEVELOPMENT TAX MAP 201 LOT 2SAGAMORE ROAD PORTSMOUTH, NH 03801

<u>TITLE:</u>

GRADING AND DRAINAGE PLAN



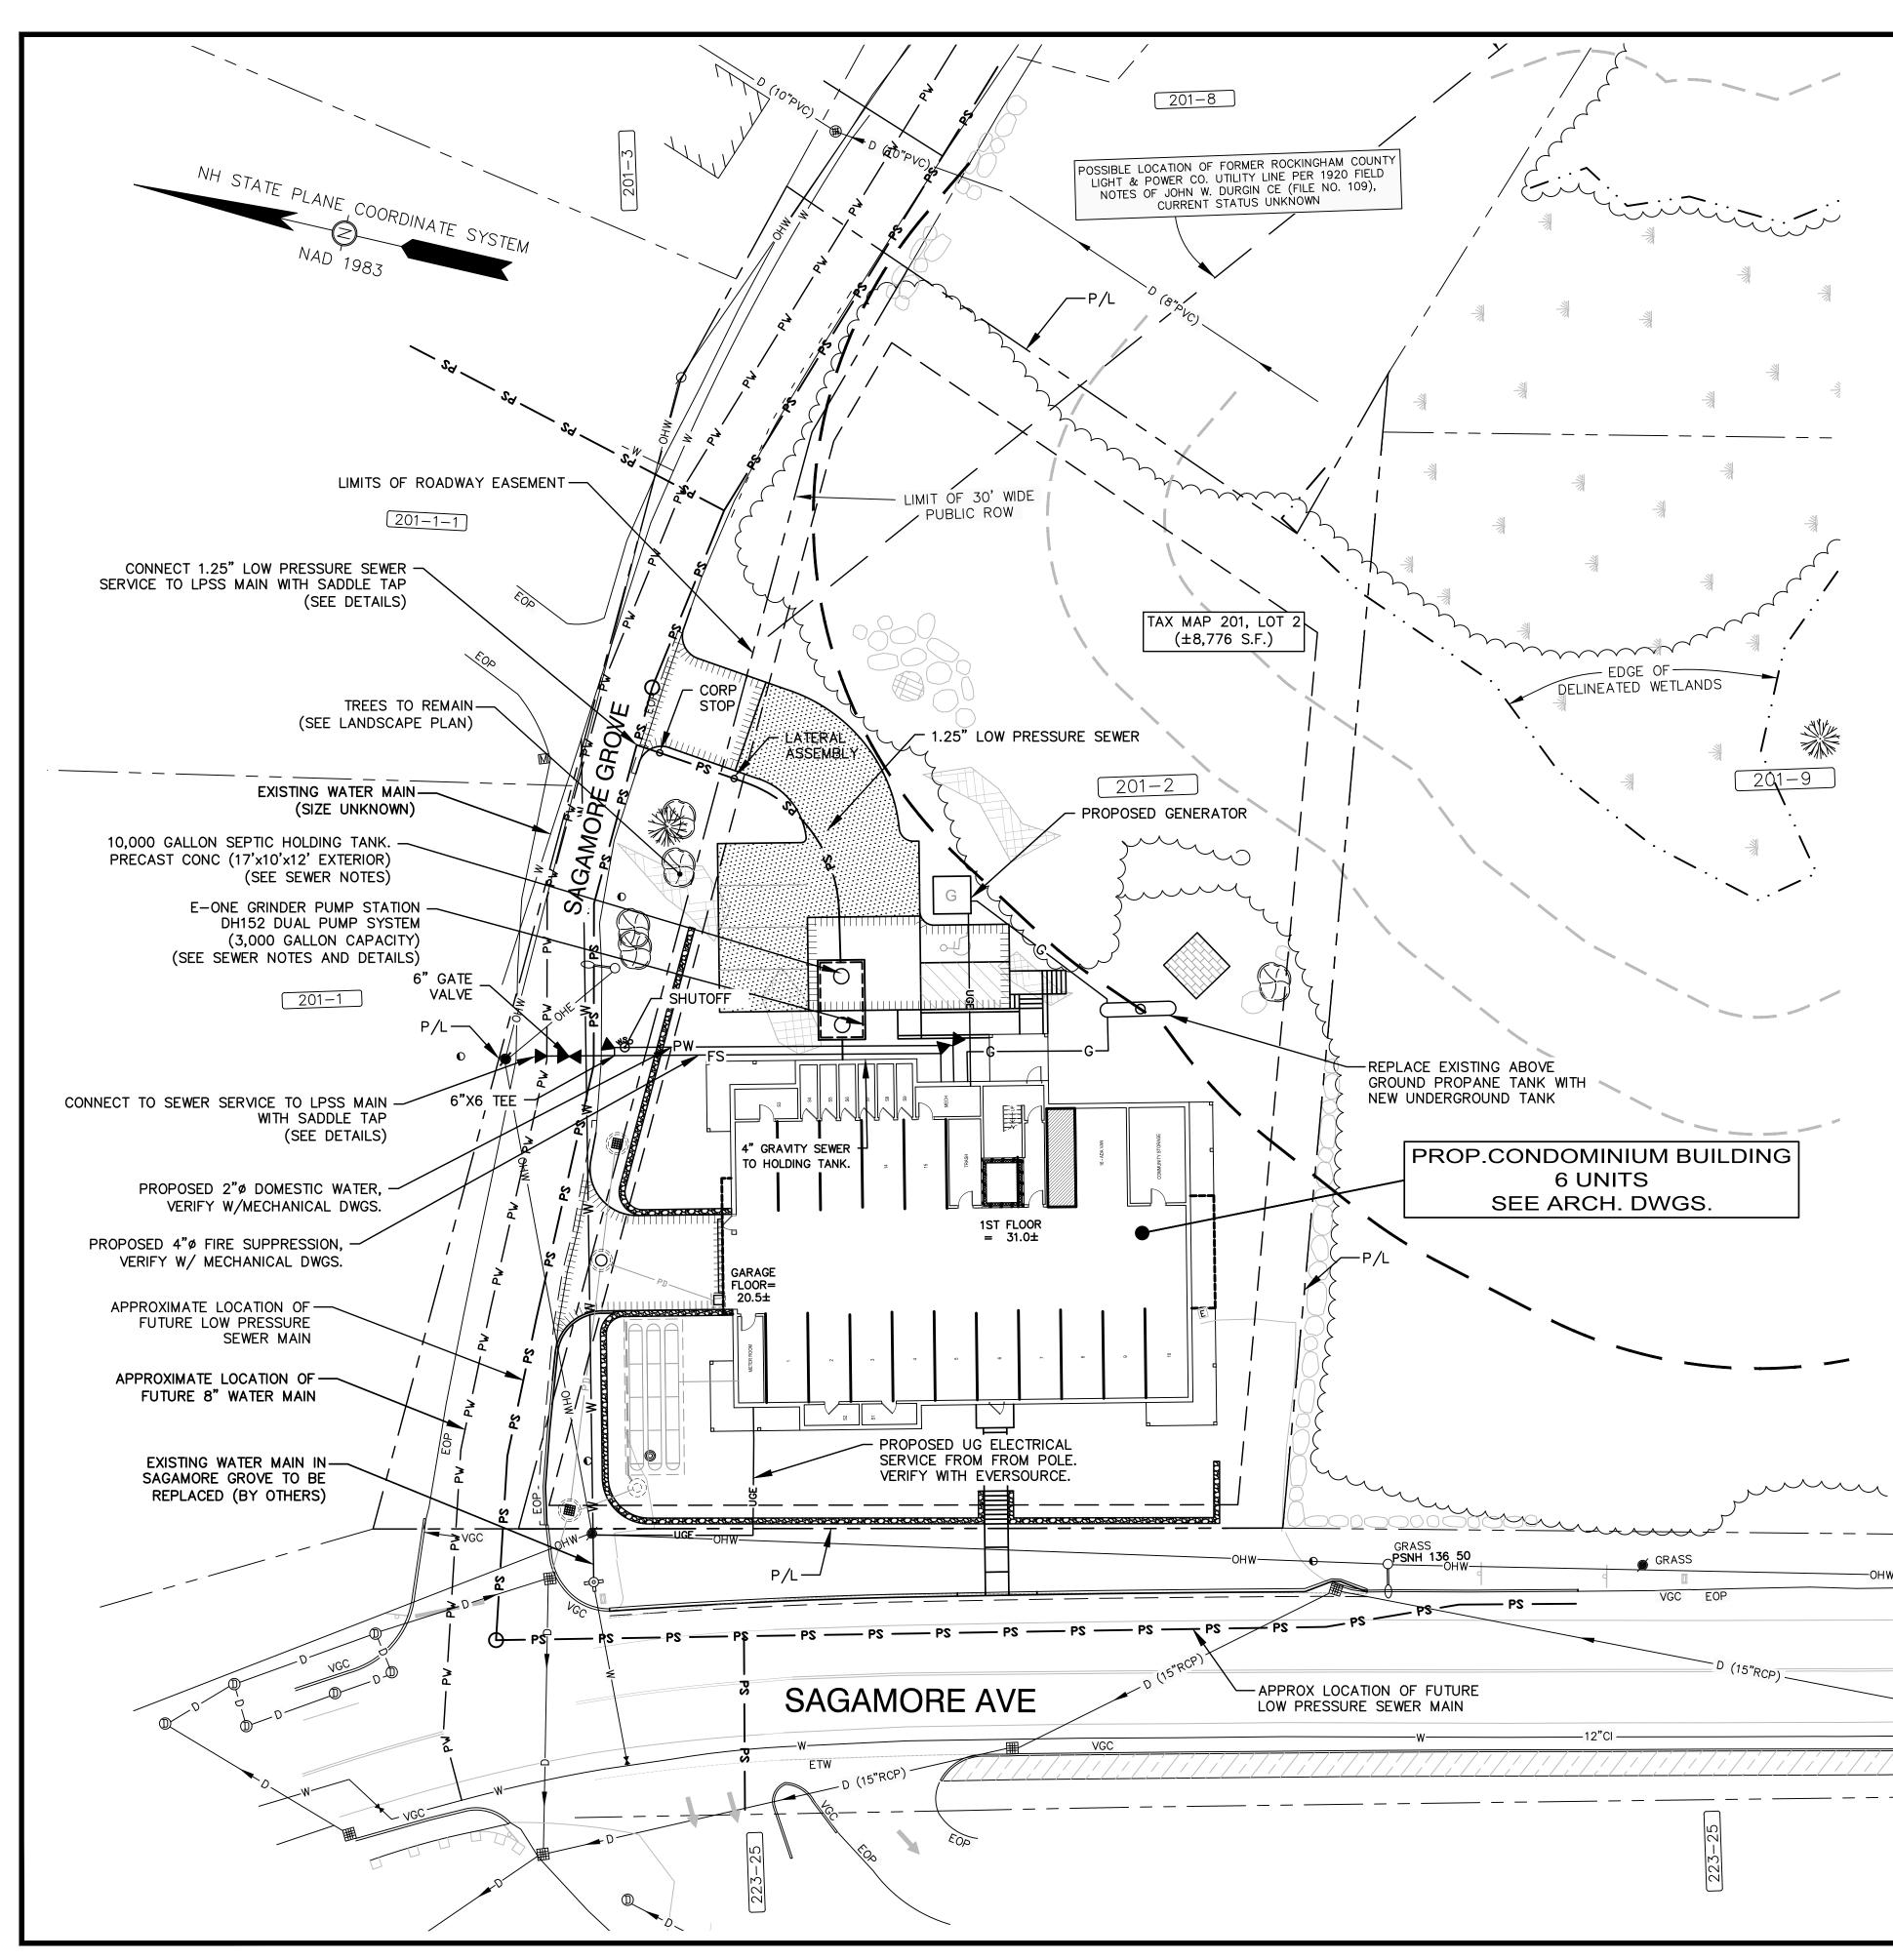


UTILITY NOTES

- THE PORTSMOUTH POLICE DEPARTMENT AND/OR PORTSMOUTH DPW
- CONNECTION FEES.
- ALL JOINTS SHALL HAVE THREE (3) WEDGES PER JOINT.
- COORDINATE WITH CITY OF PORTSMOUTH WATER DEPARTMENT.
- 6. COORDINATE ALL PANEL LOCATIONS AND INTERCONNECTIONS WITH FIRE DEPARTMENT.
- INSTALL A SIGNAL REPEATER EITHER ON OR NEAR THE PROPOSED PROJECT, THOSE COSTS SHALL BE THE
- SITEWORK CONTRACTOR SHALL COORDINATE ALL WORK WITH MECHANICAL DRAWINGS. 10.
- ATTENTION OF THE ENGINEER IMMEDIATELY AND PRIOR TO COMMENCING RELATED WORK.
- FINAL UTILITY LOCATIONS TO BE COORDINATED BETWEEN THE CONTRACTOR, ALL APPROPRIATE UTILITY 11. COMPANIES AND THE ARCHITECT.
- 12. COMMUNICATIONS.
- CONTRACTOR SHALL COORDINATE ALL CABLE INSTALLATIONS WITH COMCAST. 13. 14.
- 15. THE RESPECTIVE UTILITY PROVIDERS.

SEWER NOTES

- ALLOWABLE FUNDING.
- 1.1. STATION AND DISCHARGE TO THE 2" LOW PRESSURE SEER IN SAGAMORE GROVE.
- 1.2. WILL B USED TO HOUSE THE NEW E-ONE PUMP STATION.
- WORKS AT 603-427-1530 TO COORDINATE INSPECTION OF SEWER AND WATER WORK.

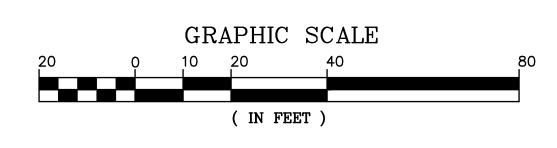

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ALL ROAD/LANE CLOSURES OR OTHER TRAFFIC INTERRUPTIONS ON CITY ROADS SHALL BE COORDINATED WITH

DO NOT BEGIN CONSTRUCTION UNTIL ALL STATE, LOCAL, AND FEDERAL PERMITS HAVE BEEN APPLIED FOR AND RECEIVED. CONTRACTOR SHALL FAMILIARIZE THEMSELVES WITH ALL PERMIT CONDITIONS AND REQUIREMENTS. THE CONTRACTOR SHALL BE RESPONSIBLE FOR POSTING OF ALL BONDS AND PAYMENT OF ALL TAP, TIE-IN AND

ALL WATER MAIN INSTALLATIONS AND SERVICE CONNECTIONS SHALL CONFORM TO PORTSMOUTH WATER DEPARTMENT STANDARDS. WATER MAIN SHALL BE WRAPPED WITH A WATER TIGHT POLYETHYLENE WRAPPING.

THE WATER MAIN IN SAGAMORE GROVE WILL BE REPLACED AT THE SAME TIME AS THE LOW PRESSURE SEWER INSTALLATION. THE NEW WATER SERVICE SHALL CONNECT TO ACTIVE MAIN LINE SAGAMORE GROVE.

FIRE ALARM PANEL SHALL MONITORED THROUGH A THIRD-PARTY SECURITY COMPANY. CONTRACTOR SHALL

THE APPLICANT SHALL HAVE A SITE SURVEY CONDUCTED BY A RADIO COMMUNICATIONS CARRIER APPROVED BY THE CITY'S COMMUNICATION DIVISION. THE RADIO COMMUNICATIONS CARRIER MUST BE FAMILIAR AND CONVERSANT WITH THE POLICE AND RADIO CONFIGURATION. IF THE SITE SURVEY INDICATES IT IS NECESSARY TO

RESPONSIBILITY OF THE PROPERTY OWNER. THE APPLICANT SHALL BE REQUIRED TO PAY FOR THE SITE SURVEY WHETHER OR NOT THE SURVEY INDICATES A REPEATER IS NECESSARY. THE OWNER SHALL COORDINATE WITH THE SUPERVISOR OF RADIO COMMUNICATIONS FOR THE CITY. THE SURVEY SHALL BE COMPLETED AND THE REPEATER, IF DETERMINED IT IS REQUIRED, SHALL BE INSTALLED PRIOR TO THE ISSUANCE OF CERTIFICATE OF OCCUPANCY. ALL TRENCHING, PIPE LAYING AND BACKFILLING SHALL CONFORM TO FEDERAL OSHA AND CITY REGULATIONS.

SEE ARCHITECTURAL/MECHANICAL DRAWINGS FOR EXACT LOCATIONS & ELEVATIONS OF UTILITY CONNECTIONS AT BUILDINGS. COORDINATE ALL WORK WITHIN FIVE (5) FEET OF BUILDINGS WITH BUILDING CONTRACTOR AND ARCHITECTURAL/MECHANICAL DRAWINGS. ALL CONFLICTS AND DISCREPANCIES SHALL BE BROUGHT TO THE

CONTRACTOR SHALL COORDINATE ALL TELECOMMUNICATIONS INSTALLATIONS WITH CONSOLIDATED

CONTRACTOR SHALL COORDINATE ALL ELECTRICAL INSTALLATIONS WITH EVERSOURCE. ALL ELECTRIC CONDUIT INSTALLATION SHALL BE INSPECTED BY EVERSOURCE PRIOR TO BACKFILL, 48-HOUR MINIMUM NOTICE REQUIRED. DETECTABLE WARNING TAPE SHALL BE PLACED OVER THE ENTIRE LENGTH OF ALL BURIED UTILITIES, COLORS PER

THE PROJECT HAS TWO OPTIONS FOR SEWER SERVICE. THE CITY OF PORTSMOUTH INTENDS TO INSTALL A NEW LOW PRESSURE SEWER FORCE MAIN ALONG SAGAMORE GROVE AS AN AGREEMENT TO THE CONSENT DECREE WITH USEPA. IF THE SEWER CONSTRUCTION IS ESTIMATED TO BE COMPLETED IN NOVEMBER OF 2022, PENDING

IF THE LOW PRESSURE SEWER MAIN IS COMPLETE, THE PROJECT WILL INSTALL AN E-ONE GRINDER PUMP

IF THE LOW PRESSURE SEWER IN SAGAMORE GROVE IS NOT COMPLETE, THE PROJECT WILL INSALL A 10,000 GALLON TEMPORARY HOLDING TANK. WHEN THE LPSS IS COMPLETED, THE HOLDING TANK WILL

ALL SEWER INSTALLATIONS AND SERVICE CONNECTIONS SHALL CONFORM TO PORTSMOUTH WATER AND SEWER DEPARTMENT STANDARDS. CONTRACTOR SHALL CONTACT CITY OF PORTSMOUTH DEPARTMENT OF PUBLIC

DO NOT BEGIN CONSTRUCTION UNTIL ALL STATE, LOCAL, AND FEDERAL PERMITS HAVE BEEN APPLIED FOR AND RECEIVED. CONTRACTOR SHALL FAMILIARIZE THEMSELVES WITH ALL PERMIT CONDITIONS AND REQUIREMENTS. ELEVATOR SUMP TO BE CONSTRUCTED MONOLITHICALLY AND SEALED TO BE WATER TIGHT. ELEVATOR TO OPERATE ON BELT SYSTEM, NOT HYDRAULICS. EMERGENCY PUMP IN ELEVATOR SUMP TO TIE INTO SEWER.

ENGINEERING, INC. 133 COURT STREET PORTSMOUTH, NH 03801 (603) 433–2335 www.ALTUS–ENG.com

NOT FOR CONSTRUCTION

ISSUED FOR: TAC WORK SESSION **ISSUE DATE:** NOVEMBER 2, 2021 <u>REVISIONS</u> NO. DESCRIPTION BY DATE 0 INITIAL SUBMITTAL CDB 11/02/2

DRAWN BY: APPROVED BY: DRAWING FILE:

 $22^{"}x34" 1" = 20'$ <u>SCALE:</u> $11" \times 17" 1" = 40'$

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<u>OWNER:</u>

WENTWORTH CORNER, LLC

1150 SAGAMORE AVENUE PORTSMOUTH, NH 03801

APPLICANT: KATZ DEVELOPMENT CORPORATION

> 273 CORPORATE DRIVE PORTSMOUTH, NH 03801

PROJECT: PROPOSED MULTI-FAMILY RESIDENTIAL DEVELOPMENT TAX MAP 201 LOT 2SAGAMORE ROAD PORTSMOUTH, NH 03801

<u>TITLE:</u>

UTILITIES PLAN



SEDIMENT AND EROSION CONTROL NOTES			
PROJECT NAME AND LOCATION	INICT	ALLATION, MAINTEN	
Owner: WENTWORTH CORNER, LLC		SION AND SEDIMEN	
1150 SAGAMORE AVENUE PORTSMOUTH, NH 03801	2.	Guidelines for Winter Mu	Ich Application
		Туре	<u>Rate per</u>
<u>DESCRIPTION</u> The project consists of the redevelopment of a commercial retail property on Sagamore Road.		Hay or Straw	70 to 90
The existing building will be razed and replaced with a modern 2-story residential building containing six (6) new residential units, underground parking, and site amenities. Stormwater will be managed and treated with sub-surface chambers and porous pavement. Site improvements		Wood Chips or Bark Mulch	460 to 92
include underground utilities, landscaping and associated site improvements. <u>DISTURBED AREA</u> The total area to be disturbed on the parcel and for the building, driveway, parking area,		Jute and Fibrous Matting (Erosion	As per mo Specificatio
drainage, and utility construction is approximately 26,500 SF± (less than 1-acre). The combined disturbed area does NOT exceed 43,560 SF (1 acre), thus a SWPPP will NOT be required for compliance with the USEPA-NPDES Construction General Permit. All local		Blanket Crushed Stone 1/4" to 1-1/2" dia.	Spread mo 1/2" thick
requirements for stormwater adn erosion control during constyruction are still required.		Erosion Control Mix	2" thick (
<u>NPDES CONSTRUCTION GENERAL PERMIT</u> <u>exempt</u> Contractor shall is NOT required to prepare a Stormwater Pollution Prevention Plan (SWPPP) or file an NOI (Notice of Intent) in accordance with federal storm water permit requirements under the USEPA-NPDES Construction General Permit.			
<u>SEQUENCE OF MAJOR ACTIVITIES</u> 1. Hold a pre-construction meeting with City & stake holders.			
 Install temporary erosion control measures, including drain inlet protection, silt fences, and stabilized construction exit/entrance. 	3.	Maintenance — All mulch for rill erosion. If less	
3. Remove existing bulding, disconnect and remove utilities.	C.	immediately applied. TEMPORARY GRASS COVE	Ð
4. Clear and Grub vegetated areas per plan; Strip and stockpile loam. Stockpiles shall be temporarily stabilized with hay bales, mulch and surrounded by a hay bale or silt fence barrier until material is removed and final grading is complete. Remove debris. Remove pavement and structures intended to be removed within the		Seedbed Preparation -	.N
initial work limits. 5. Construct utility infrastructure. Rough grade lot to prepare for site development. Stabilize swales		Apply fertilizer at the ro percent calcium plus mo	•
prior to directing flow to them. 6. Construct Foundations and underground garage parking. install temporary septic holding tank.	2.	Seeding –	
7. Construct building. Construct pavement & driveway access.		a. Utilize annual b. Where the so	il has been co
8. Construct stormwater treatment chambers.		c. Apply seed u	
9. Loam and seed disturbed areas.			ydroseedings, w e increased 10
10. When all construction activity is complete and site is stabilized, remove all silt fences and temporary structures and sediment that has been trapped by these devices.	3.	Maintenance — Temporary seedings sha be covered by vegetatio	
NAME OF RECEIVING WATER		made and other tempor	ary measures (
The site drainage discharges into a municipal closed drainage system outletting to Sagamore Creek.	D.	FILTERS	
TEMPORARY EROSION & SEDIMENT CONTROL AND STABILIZATION PRACTICES All work shall be in accordance with state and local permits. Work shall conform to the practices	1.	Tubular Sediment Barrier a. See detail. b. Install per me	
described in the "New Hampshire Stormwater Manual, Volumes 1 — 3", issued December 2008, as amended. As indicated in the sequence of Major Activities, the silt fences shall be installed prior to commencing any clearing or grading of the site. Structural controls shall be installed concurrently with the applicable activity. Once construction activity ceases permanently in an area, silt fences and any earth/dikes will be removed once permanent measures are established.	2.	Silt Fence (if used) a. Synthetic filte yarn and sha requirements:	r fabric shall t Il be certified
During construction, runoff will be diverted around the site with stabilized channels where possible. Sheet		<u>Physical Property</u> Filtering Efficienc	
runoff from the site shall be filtered through hay bale barriers, stone check dams, and silt fences. All storm drain inlets shall be provided with hay bale filters or stone check dams. Stone rip rap shall be provided at the outlets of drain pipes and culverts where shown on the drawings.		Tensile Strength 20% Maximum El	at
Stabilize all ditches, swales, stormwater ponds, level spreaders and their contributing areas prior to directing flow to them.			
Temporary and permanent vegetation and mulching is an integral component of the erosion and		Flow Rate	
sedimentation control plan. All areas shall be inspected and maintained until vegetative cover is established. These control measures are essential to erosion prevention and also reduce costly rework of graded and shaped areas.		* Requirements r	educed by 50
Temporary vegetation shall be maintained in these areas until permanent seeding is applied. Additionally, erosion and sediment control measures shall be maintained until permanent vegetation is established.		Synthetic filter fo minimum of six 0 degrees F to	(6) months of
INSTALLATION, MAINTENANCE AND INSPECTION PROCEDURES FOR TEMPORARY EROSION AND SEDIMENT CONTROL MEASURES		b. Posts shall b recommended inches).	e spaced a mo by the manuf
A. GENERAL		c. A trench sha	
These are general inspection and maintenance practices that shall be used to implement the plan:		-	e of posts and
1. The smallest practical portion of the site shall be denuded at one time, but in no case shall it exceed 5 acres at one time.		inch long, tie	a strengtn filte ne upslope side wires or hog pround surfaces
 All control measures shall be inspected at least once each week and following any storm event of 0.25 inches or greater. All measures shall be maintained in good working order; if a rengin is pecessary, it will be initiated 		e. The "standard	
 All measures shall be maintained in good working order; if a repair is necessary, it will be initiated within 24 hours. Built—up sediment shall be removed from silt fence or other barriers when it has reached one—third the height of the fence or bale, or when "bulges" occur. 		inches of the	fabric shall be es above the c
5. All diversion dikes shall be inspected and any breaches promptly repaired. 6. Temporary seeding and planting shall be inspected for bare spots, washouts, and unhealthy growth. 7. The owner's authorized engineer shall inspect the site on a periodic basis to review compliance with		-	trength filter fo e eliminated. I h all other pro
the Plans. 8. All roadways and parking lots shall be stabilized within 72 hours of achieving finished grade.			2

- 9. All cut and fill slopes shall be seeded/loarned within 72 hours of achieving finished grade.
- 10. An area shall be considered stable if one of the following has occurred: a. Base coarse gravels have been installed in areas to be paved;
 - b. A minimum of 85% vegetated growth as been established; c. A minimum of 3 inches of non-erosive material such as stone of riprap has been installed:
- or d. Erosion control blankets have been properly installed.
- 11. The length of time of exposure of area disturbed during construction shall not exceed 45 days. B. MULCHING
- Mulch shall be used on highly erodible soils, on critically eroding areas, on areas where conservation of moisture will facilitate plant establishment, and where shown on the plans.
- 1. Timing In order for mulch to be effective, it must be in place prior to major storm
- events. There are two (2) types of standards which shall be used to assure this: a. Apply mulch prior to any storm event. This is applicable when working within 100 feet of wetlands. It will be necessary to closely monitor weather predictions, usually by contacting the National Weather Service in Concord, to have adequate warning of significant storms.
 - b. Required Mulching within a specified time period. The time period can range from 21 to 28 days of inactivity on a area, the length of time varying with site conditions. Professional judgment shall be used to evaluate the interaction of site conditions (soil erodibility, season of year, extent of disturbance, proximity to sensitive resources, etc.) and the potential impact of erosion on adjacent areas to choose an appropriate time restriction.

INSPECTION PROCEDURES FOR TEMPORARY L MEASURES (CON'T)

_

e per 1.000 s.f. to 90 lbs. from with planting	<u>Use and Comments</u> Must be dry and free mold. May be used s.
to 920 lbs.	Used mostly with trees and shrub plantings.
per manufacturer cifications	Used in slope areas, water courses and other Control areas.
ad more than ' thick	Effective in controlling wind and water erosion.
	 * The organic matter content is between 80 and 100%, dry weight basis. * Particle size by weight is 100% passing a 6"screen and a minimum of 70 %, maximum of 85%, passing a 0.75" screen. * The organic portion needs to be fibrous longated. * Large portions of silts, clays or fine sands bt acceptable in the mix. * Soluble salts content is less than 4.0 s/cm. * The pH should fall between 5.0 and 8.0.

nspected periodically, in particular after rainstorms, to check the soil surface is covered by mulch, additional mulch shall be

unds per acre of 10-10-10. Apply limestone (equivalent to 50 le) at a rate of three (3) tons per acre.

a rate of 40 lbs/acre.

- mpacted by construction operations, loosen soil to a depth of ying fertilizer, lime and seed. and, cyclone seeder, or hydroseeder (slurry including seed and
- which include mulch, may be left on soil surface. Seeding 0% when hydroseeding.

lly inspected. At a minimum, 95% of the soil surface should lence of erosion or sedimentation is apparent, repairs shall be used in the interim (mulch, filter barriers, check dams, etc.).

equirements.

be a pervious sheet of propylene, nylon, polyester or ethylene by the manufacturer or supplier as conforming to the following

<u>Test</u>	<u>Requirements</u>
VTM-51	75% minimum
VTM-52	Extra Strength 50 lb/lin in (min) Standard Strength 30 lb/lin in (min)

0.3 gal/sf/min (min) VTM-51

percent after six (6) months of installation

ain ultraviolet ray inhibitors and stabilizer to provide a expected usable construction life at a temperature range of

aximum of ten (10) feet apart at the barrier location or as facturer and driven securely into the ground (minimum of 16

approximately six (6) inches wide and eight (8) inches deep upslope from the barrier.

er fabric is used, a wire mesh support fence shall be fastened of the posts using heavy duty wire staples at least one (1) rings. The wire shall extend no more than 36 inches above

ter fabric shall be stapled or wired to the fence, and eight (8) be extended into the trench. The fabric shall not extend more original ground surface. Filter fabric shall not be stapled to

abric and closer post spacing are used, the wire mesh support In such a case, the filter fabric is stapled or wired directly to ovisions of item (g) applying.

g. The trench shall be backfilled and the soil compacted over the filter fabric.

3. Sequence of Installation -

drainage area.

4. Maintenance -

promptly.

h. Silt fences shall be removed when they have served their useful purpose but not before the upslope areas has been permanently stabilized.

Sediment barriers shall be installed prior to any soil disturbance of the contributing upslope

a. Silt fence barriers shall be inspected immediately after each rainfall and at least daily during prolonged rainfall. They shall be repaired if there are any signs of erosion or sedimentation below them. Any required repairs shall be made immediately. If there are signs of undercutting at the center or the edges, or impounding of large volumes of water, the sediment barriers shall be replaced with a temporary stone check dam.

b. Should the fabric on a silt fence or filter barrier decompose or become ineffective prior to the end of the expected usable life and the barrier still is necessary, the fabric shall be replaced

c. Sediment deposits must be removed when deposits reach approximately one-third (1/3) the height of the barrier.

d. Any sediment deposits remaining in place after the silt fence or other barrier is no longer required shall be removed. The area shall be prepared and seeded.

- e. Additional stone may have to be added to the construction entrance, rock barrier and riprap lined swales, etc., periodically to maintain proper function of the erosion control structure.
- E. PERMANENT SEEDING -
- 1. Bedding stones larger than $1\frac{1}{2}$ ", trash, roots, and other debris that will interfere with seeding and future maintenance of the area should be removed. Where feasible, the soil should be tilled to a depth of 5" to prepare a seedbed and mix fertilizer into the soil.
- 2. Fertilizer lime and fertilizer should be applied evenly over the area prior to or at the time of seeding and incorporated into the soil. Kinds and amounts of lime and fertilizer should be based on an evaluation of soil tests. When a soil test is not available, the following minimum amounts should be applied:

Agricultural Limestone @ 100 lbs. per 1,000 s.f. 10-20-20 fertilizer @ 12 lbs. per 1.000 s.f.

3. Seed Mixture (See Landscape Drawings for additional information):

- 3.1. Lawn seed mix shall be a fresh, clean new seed crop. The Contractor shall furnish a dealer's guaranteed statement of the composition of the mixture and the percentage of purity and germination of each variety. 3.2. Seed mixture shall consist of

 - a. 1/3 Kentucky blue, b. 1/3 perennial rye, and
- c. 1/3 fine fescue.
- 3.1. Turf type tall fescue is unacceptable
- 4. Sodding sodding is done where it is desirable to rapidly establish cover on a disturbed area. Sodding an area may be substituted for permanent seeding procedures anywhere on site. Bed preparation, fertilizing, and placement of sod shall be performed according to the S.C.S. Handbook. Sodding is recommended for steep sloped areas, areas immediately adjacent to sensitive water courses, easily erodible soils (fine sand/silt), etc.


WINTER CONSTRUCTION NOTES

- 1. All proposed vegetated areas which do not exhibit a minimum of 85% vegetative growth by October 15th, or which are disturbed after October 15th, shall be stabilized by seeding and installing erosion control blankets on slopes greater than 3:1, and elsewhere seeding and placing 3 to 4 tons of mulch per acre, secured with anchored netting. The installation of erosion control blankets or mulch and netting shall not occur over accumulated snow or on frozen ground and shall be completed in advance of thaw or spring melt events;
- 2. All ditches or swales which do not exhibit a minimum of 85% vegetative growth by October 15th, or which are disturbed after October 15th, shall be stabilized temporarily with stone or erosion control blankets appropriate for the design flow conditions; and
- 3. After November 15th, incomplete road or parking surfaces where work has stopped for the winter season shall be protected with a minimum of 3 inches of crushed gravel per NHDOT Item 304.3.

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	Spring	dl or carly	After Major Storm	Every 2-5 Years
	Sp	Fa Ye	A M S	19 ° ×
Vegetated Areas			1	
Inspect all slopes and embankments	х		X	
Replant bare areas or areas with sparse growth	X		X	
Armor areas with rill erosion with an appropriate lining or divert the erosive flows to on-site areas	x		x	
able to withstand concentrated flows.				
Stormwater Channels				
Inspect ditches, swales and other open stormwater	х	x	x	
channels				
Remove any obstructions and accumulated sediments or debris	x	x		
Control vegetated growth and woody vegetation		x		
Repair any erosion of the ditch lining		x		
Mow vegetated ditches		x		
Remove woody vegetation growing through riprap		x		
Repair any slumping side slopes		x		
Replace riprap where underlying filter fabric or		x		
underdrain gravel is exposed or where stones have been dislodged				
Culverts				
Remove accumulated sediments and debris at inlet, outlet and within the conduit	x	x	x	
Repair any erosion damage at the culvert's inlet and outlet	x	x	x	
Remove woody vegetation growing through riprap Roadways and Parking Surfaces		x]	
Remove accumulated winter sand along roadways	x	1	1	1
Sweep pavement to remove sediment	x			
Grade road shoulders and remove excess sand	x			
either manually or by a front-end loader	^			
Grade gravel roads and gravel shoulders	x			+
Clean out sediment contained in water bars or	X			-
open-top culverts	^			
Ensure that stormwater is not impeded by	x			
accumulations of material or false ditches in the				
roadway shoulder				
Runoff Infiltration Facilities				
Remove dead vegetation and any accumulated	x			
sediment (normally at the entrance to the garden)				
to allow for new growth				
Weed; add additional hardwood mulch to suppress	x	x		
weeds				+
Mow turf three (3) times a growing season				+
Aerate area with deep tines, if water ponds on the		x		
surface for more than 24 hours during the first year or for a length of 72 hours				
Vegetative Swale				
Mow grass swales monthly				
Inspect swale following significant rainfall event	x	x	x	
Control vegetated growth and woody vegetation	х	x		
Repair any erosion of the ditch	x	X		



EXISTING GROUND

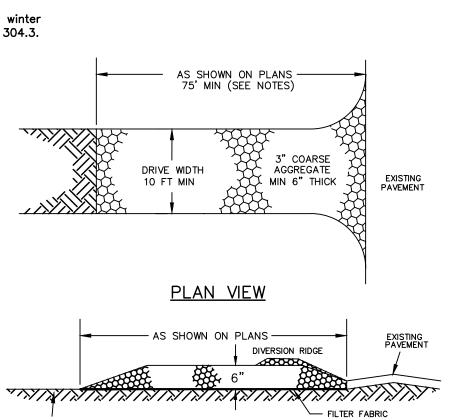CONSTRUCTION SPECIFICATIONS

1.	REFERENCE NEW HA
	TEMPORARY CONST
2.	<u>STONE SIZE</u> – 3" C
3.	THICKNESS - SIX (6
4.	<u>LENGTH</u> – 75 FOOT
5.	<u>WIDTH</u> - 1/2 OF DR
6.	<u>FILTER FABRIC</u> – MII
7.	SURFACE WATER CO


- SUBSTITUTED FOR THE PIPE.
- REMOVED IMMEDIATELY. 9.

ALL FACILITIES SHOULD BE INSPECTED ON AN ANNUAL BASIS AT A MINIMUM. IN ADDITION, ALL FACILITIES SHOULD BE INSPECTED AFTER A SIGNIFICANT PRECIPITATION EVENT TO ENSURE THE FACILITY IS DRAINING APPROPRIATELY AND TO IDENTIFY ANY DAMAGE THAT OCCURRED AS A RESULT OF THE INCREASED RUNOFF. FOR THE PURPOSE OF THIS STORMWATER MANAGEMENT PROGRAM, A SIGNIFICANT RAINFALL EVENT IS CONSIDERED AN EVENT OF THREE (3) INCHES IN A 24-HOUR PERIOD OR 0.25 INCHES IN A ONE-HOUR PERIOD. IT IS ANTICIPATED THAT A SHORT, INTENSE EVENT IS LIKELY TO HAVE A HIGHER POTENTIAL OF EROSION FOR THIS SITE THAN A LONGER, HIGH VOLUME EVENT.

APPROVED BY THE PORTSMOUTH PLANNING BOARD

CHAIRMAN

DATE

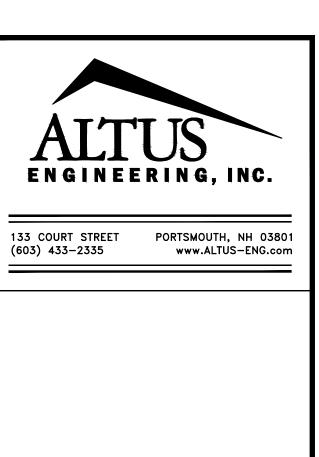

PROFILE

MPSHIRE STORMWATER MANUAL VOLUME 3 (LATEST EDITION), SECTION 4.2 TRUCTION EXIT" REQUIREMENTS AND BMP DETAIL. COARSE AGGREGATE

(6) INCHES (MINIMUM). MINIMUM, OR 50 FOOT ALLOWED WHEN DIVERSION RIDGE IS PROVIDED. RIVEWAY (10 FOOT MINIMUM).

IRAFI 600X OR APPROVED ÉQUAL. DNTROL - ALL SURFACE WATER THAT IS FLOWING TO OR DIVERTED TOWARD THE CONSTRUCTION ENTRANCE SHALL BE PIPED BENEATH THE ENTRANCE. IF PIPING IS IMPRACTICAL, A BERM WITH 5:1 SLOPES THAT CAN BE CROSSED BY VEHICLES MAY BE

8. MAINTENANCE - THE ENTRANCE SHALL BE MAINTAINED IN A CONDITION WHICH WILL PREVENT RACKING OR FLOWING OF SEDIMENT ONTO PUBLIC RIGHTS-OF-WAY. THIS WILL REQUIRE PERIODIC TOP DRESSING WITH ADDITIONAL STONE OR ADDITIONAL LENGTH AS CONDITIONS DEMAND AND REPAIR AND/OR CLEANOUT OF ANY MEASURES USED TO TRAP SEDIMENT. ALL SEDIMENT SPILLED, DROPPED, WASHED OR TRACKED ONTO PUBLIC RIGHTS-OF-WAY MUST BE

WHEELS SHALL BE CLEANED TO REMOVE MUD PRIOR TO ENTRANCE ONTO PUBLIC RIGHTS-OF-WAY. WHEN WASHING IS REQUIRED, IT SHALL BE DONE ON AN AREA STABILIZED WITH STONE WHICH DRAINS INTO AN APPROVED SEDIMENT TRAPPING DEVICE.

STABILIZED CONSTRUCTION EXIT NOT TO SCALE

NOT FOR CONSTRUCTION				
ISSUED FOR:				
	TAC	WORK	SE	SSION
ISSUE DATE:				
	NOV	EMBER	2,	2021
REVISIONS NO. DESCRIPTI 0 INITIAL SUB			BY CDB	DATE 11/02/21
				CDD

CDB DRAWN BY:_ EDW APPROVED BY: 5079-SITE.dwa DRAWING FILE: .

SCALE: 22"x34" 1" = 20' $11" \times 17" 1" = 40'$

OWNER:

WENTWORTH CORNER, LLC

1150 SAGAMORE AVENUE PORTSMOUTH. NH 03801


APPLICANT: KATZ DEVELOPMENT CORPORATION


> 273 CORPORATE DRIVE PORTSMOUTH, NH 03801


PROJECT: PROPOSED MULTI-FAMILY RESIDENTIAL DEVELOPMENT TAX MAP 201 LOT 2SAGAMORE ROAD PORTSMOUTH, NH 03801

TITLE:


EROSION CONTROL NOTES AND DETAILS

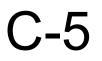

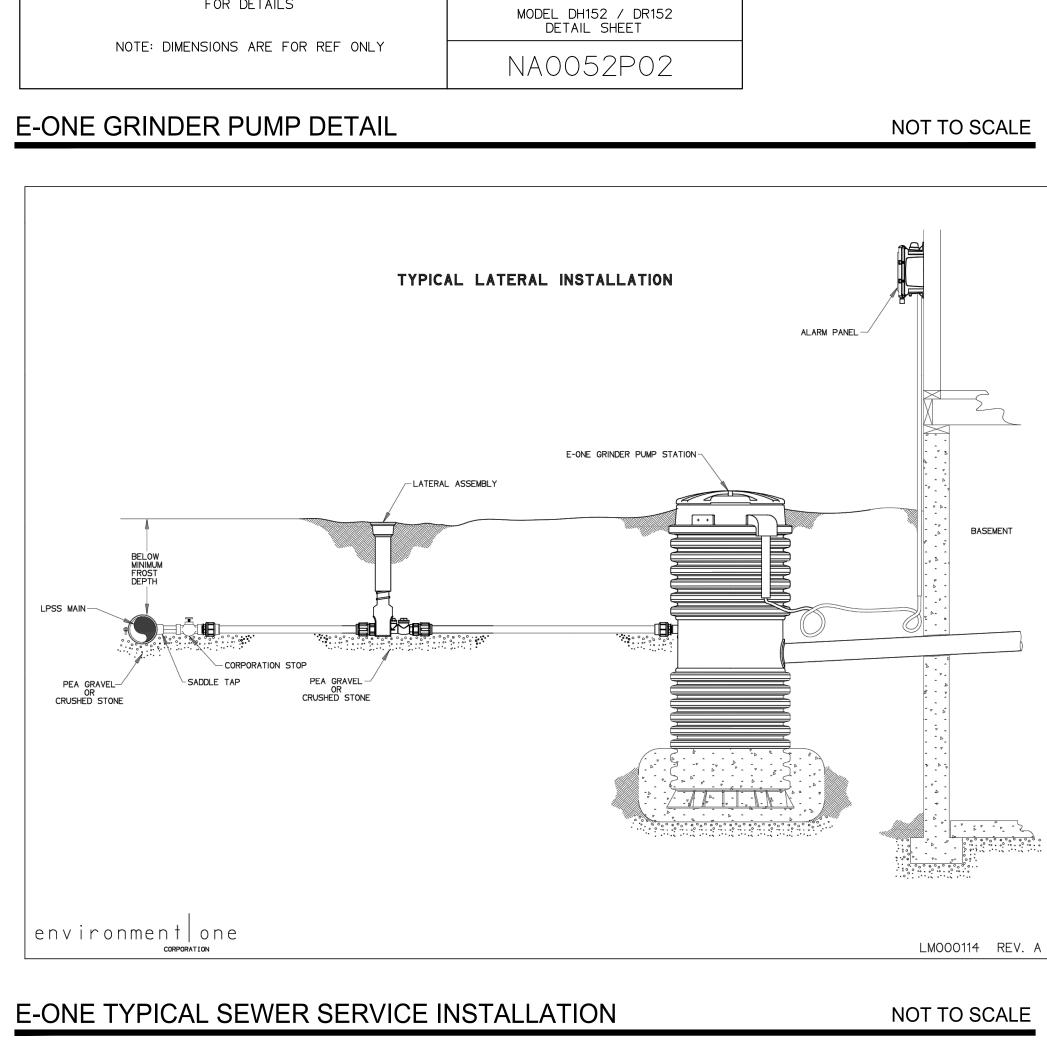

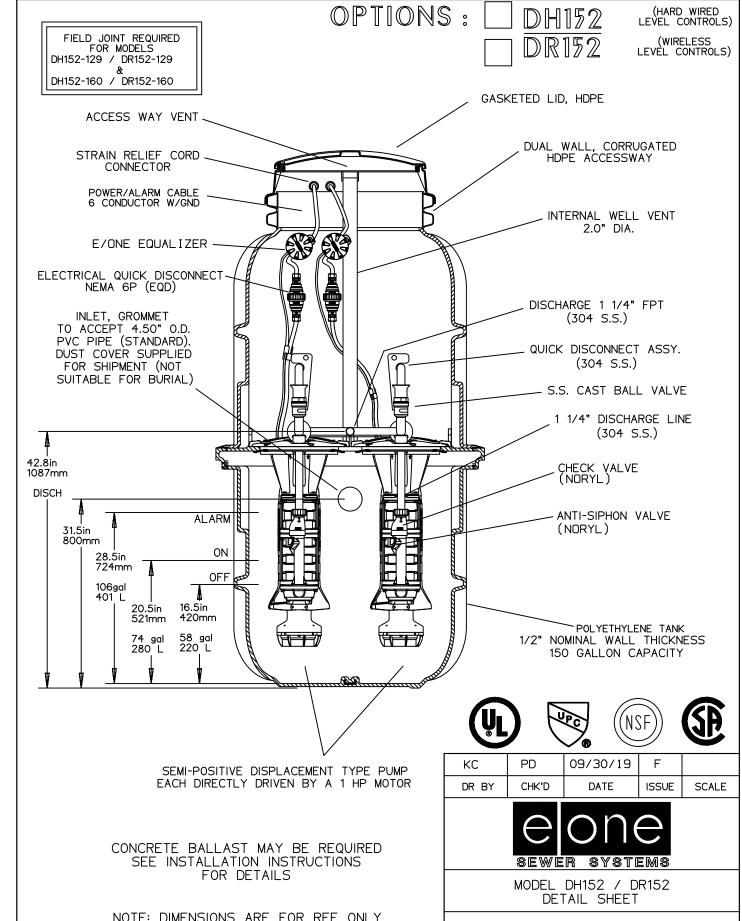

SEPTIC HOLDING TANK DETAIL (10,000 GALLON CAPACITY)

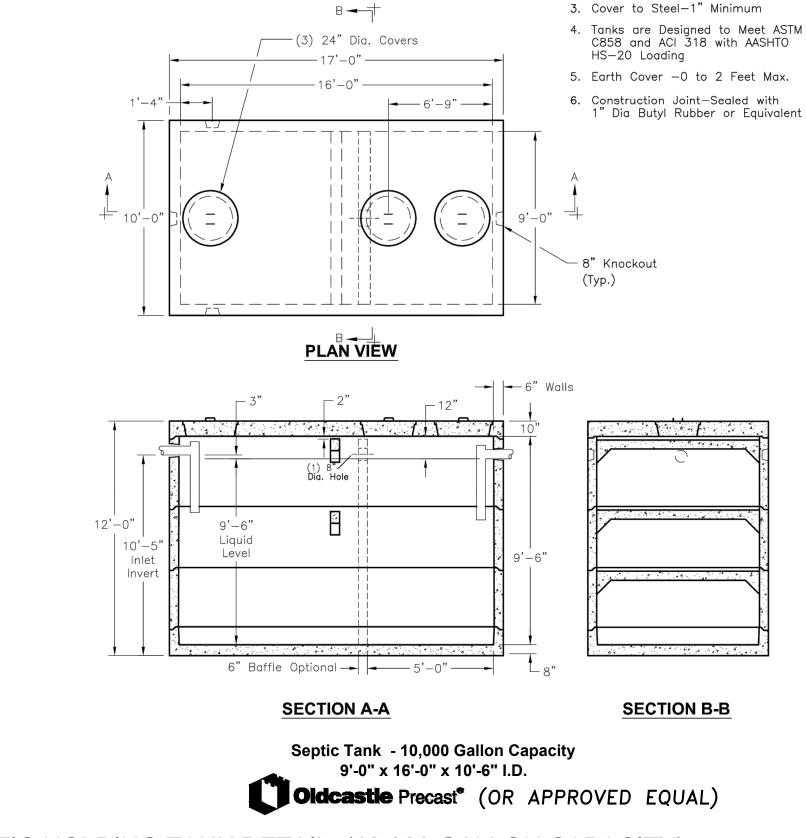


NOTES:

1. Concrete : 5,000 P.S.I

Grade 60.

Minimum Strength @ 28 Days


2. Steel Reinforcing- ASTM A-615,

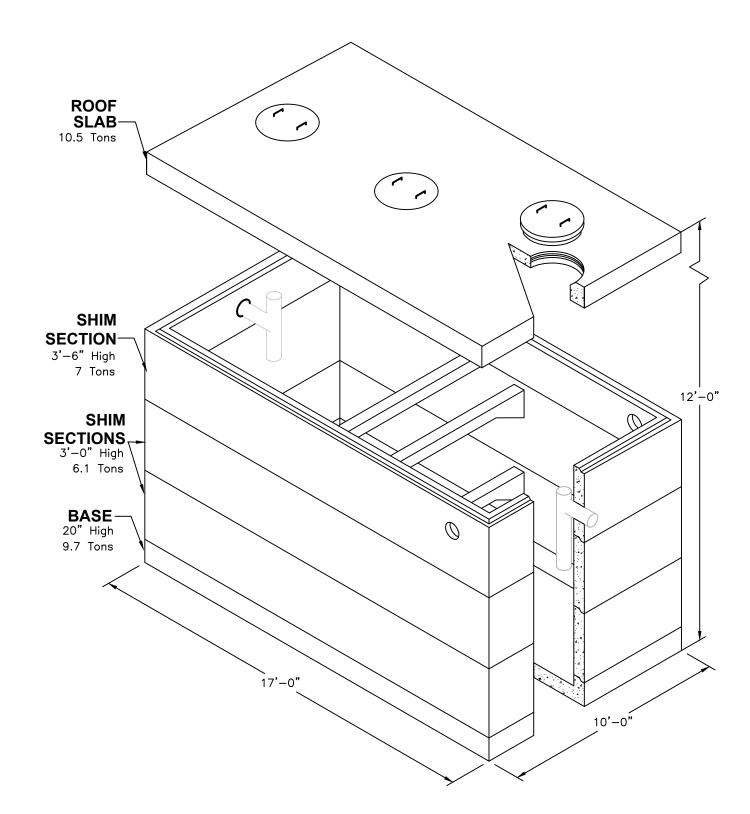

APPROVED BY THE PORTSMOUTH PLANNING BOARD

CHAIRMAN

DATE

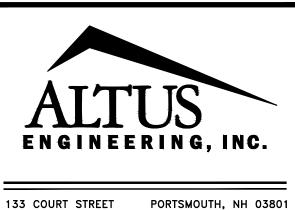

(603) 433–2335

www.ALTUS-ENG.com

NOT FOR CONSTRUCTION
ISSUED FOR:

	TAC	WORK	SE	SSION
ISSUE DATE	<u>.</u>			
	NOV	EMBER	2,	2021
REVISIONS	TION		BY	DATE

CDB 11/02/2

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CDB DRAWN BY: EDW APPROVED BY: 5079-SITE.dwg DRAWING FILE: .

SCALE:	22"x34"	1"	=	20'
	11"x17"	1"	=	40'

<u>OWNER:</u>

WENTWORTH CORNER, LLC

1150 SAGAMORE AVENUE PORTSMOUTH, NH 03801

APPLICANT: KATZ DEVELOPMENT CORPORATION

> 273 CORPORATE DRIVE PORTSMOUTH, NH 03801

PROJECT: PROPOSED MULTI-FAMILY RESIDENTIAL DEVELOPMENT TAX MAP 201 LOT 2SAGAMORE ROAD PORTSMOUTH, NH 03801

<u>TITLE:</u>

CONSTRUCTION DETAILS

SHEET NUMBER:


NOT TO SCALE

C-6



NOT TO SCALE

SILT AND ORANGE CONSTRUCTION FENCE DETAIL

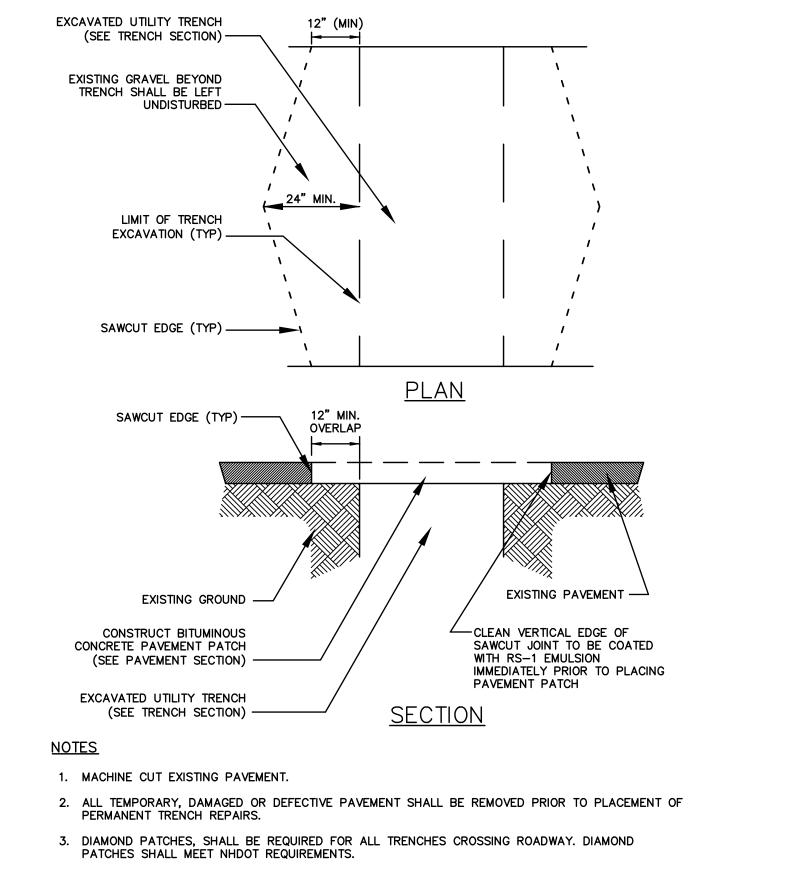


STORM DRAIN INLET PROTECTION NOT TO SCALE

UNACCEPTABLE INLET PROTECTION METHOD: A SIMPLE SHEET OF GEOTEXTILE UNDER THE GRATE IS NOT ACCEPTABLE.


MAINTENANCE: REMOVE ALL ACCUMULATED SEDIMENT AND DEBRIS FROM VICINITY OF THE UNIT AFTER EACH STORM EVENT. AFTER EACH STORM EVENT AND AT REGULAR INTERVALS, LOOK INTO THE CATCH BASIN INSERT. IF THE CONTAINMENT AREA IS MORE THAN 1/3 FULL OF SEDIMENT, THE UNIT MUST BE EMPTIED. TO EMPTY THE UNIT, LIFT THE UNIT OUT OF THE INLET USING THE LIFTING STRAPS AND REMOVE THE GRATE. IF USING OPTIONAL ABSORBENTS; REPLACE ABSORBENT WHEN NEAR SATURATION.

INSTALLATION: REMOVE THE GRATE FROM CATCH BASIN. IF USING OPTIONAL OIL ABSORBENTS; PLACE ABSORBENT PILLOW IN UNIT. STAND GRATE ON END. MOVE THE TOP LIFTING STRAPS OUT OF THE WAY AND PLACE THE GRATE INTO CATCH BASIN INSERT SO THE GRATE IS BELOW THE TOP STRAPS AND ABOVE THE LOWER STRAPS. HOLDING THE LIFTING DEVICES, INSERT THE GRATE INTO THE INLET.

INSTALLATION AND MAINTENANCE:

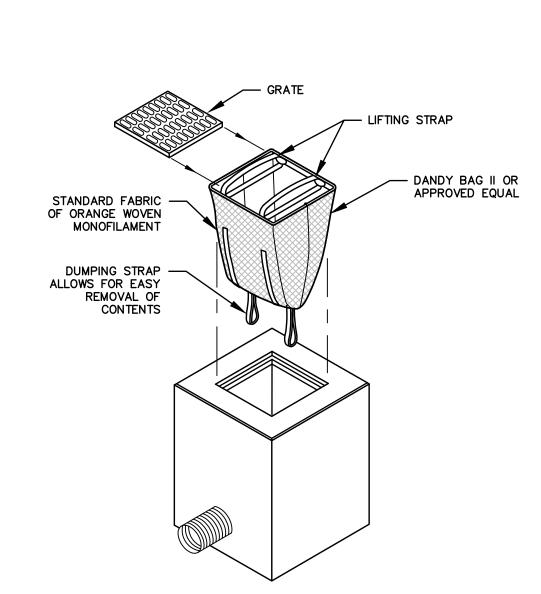

- <u>NOTES</u> FERTILIZER, AND SEED.
- 2

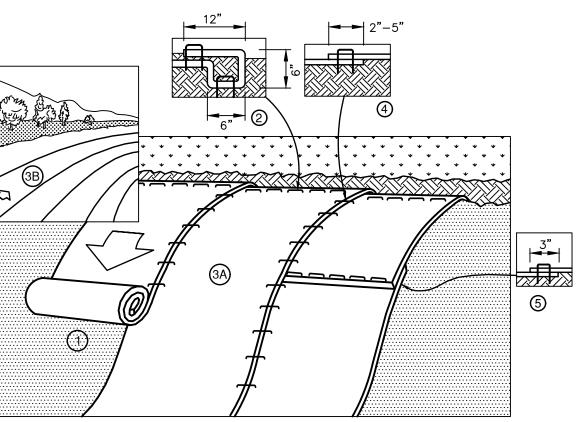

1. PREPARE SOIL BEFORE INSTALLING BLANKETS, INCLUDING ANY NECESSARY APPLICATION OF LIME,


2. BEGIN AT THE TOP OF THE SLOPE BY ANCHORING THE BLANKET IN A 6" DEEP BY 6" WIDE TRENCH WITH APPROXIMATELY 12" OF BLANKET EXTENDED BEYOND THE UP-SLOPE PORTION OF THE TRENCH. ANCHOR THE BLANKET WITH A ROW OF STAPLES/STAKES APPROXIMATELY 12" APART IN THE BOTTOM OF THE TRENCH. BACKFILL AND COMPACT THE TRENCH AFTER STAPLING. APPLY SEED TO COMPACTED SOIL AND FOLD REMAINING 12" PORTION OF BLANKET BACK OVER SEED AND COMPACTED SOIL. SECURE BLANKET OVER COMPACTED SOIL WITH A ROW OF STAPLES/STAKES SPACED APPROXIMATELY 12" APART ACROSS THE WIDTH OF THE BLANKET.

3. ROLL THE BLANKETS (A) DOWN OR (B) HORIZONTALLY ACROSS THE SLOPE. BLANKETS WILL UNROLL WITH APPROPRIÁTE SIDE AGÀIŃST THE SOIL SURFACE. ALL BLANKETS MUST BE SECURELY FASTENED TO SOIL SURFACE BY PLACING STAPLES/STAKES IN APPROPRIATE LOCATIONS AS SHOWN IN THE STAPLE PATTERN GUIDE.


4. THE EDGES OF PARALLEL BLANKETS MUST BE STAPLED WITH APPROXIMATELY 2"-5" OVERLAP DEPENDING ON BLANKET TYPE. TO ENSURE PROPER SEAM ALIGNMENT, PLACE THE EDGE OF THE OVERLAPPING BLANKET (BLANKET BEING INSTALLED ON TOP) EVEN WITH THE COLORED SEAM STITCH ON THE PREVIOUSLY INSTALLED BLANKET.

5. CONSECUTIVE BLANKETS SPLICED DOWN THE SLOPE MUST BE PLACED END OVER END (SHINGLE STYLE) WITH AN APPROXIMATE 3" OVERLAP. STAPLE THROUGH OVERLAPPED AREA, APPROXIMATELY 12" APART ACROSS ENTIRE BLANKET WIDTH. NOTE: IN LOOSE SOIL CONDITIONS, THE USE OF STAPLE OR STAKE LENGTHS GREATER THAN 6" MAY BE NECESSARY TO PROPERLY SECURE THE BLANKETS.


EROSION CONTROL BLANKET - SLOPE NOT TO SCALE

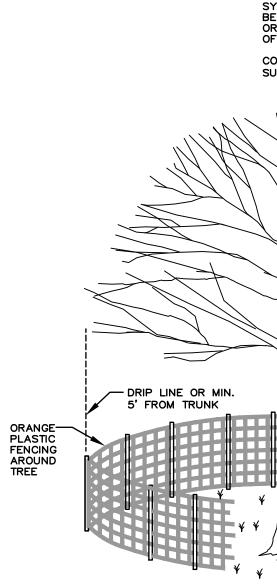

TREE PROTECTION DETAIL

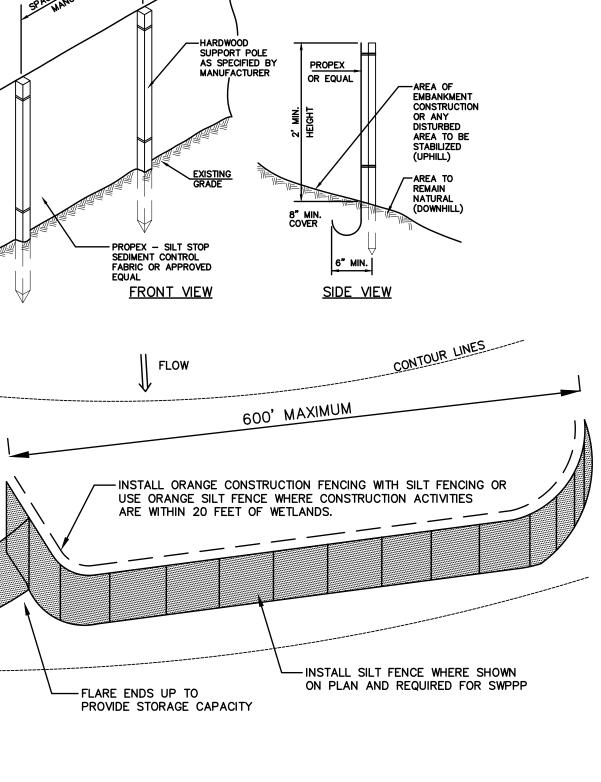

NOT TO SCALE

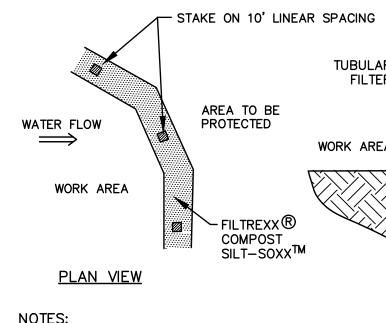



1. SILTSOXX OR APPROVED EQUAL SHALL BE USED FOR TUBU 2. ALL MATERIAL TO MEET MANUFACTURER'S SPECIFICATIONS. 3. COMPOST/SOIL/ROCK/SEED FILL MATERIAL SHALL BE ADJUS REQUIREMENTS OF THE SPECIFIC APPLICATION.

4. ALL SEDIMENT TRAPPED BY BARRIER SHALL BE DISPOSED


TUBULAR SEDIMENT BARRIE


APPROVED BY THE PORTSMOUTH PLANNING BOARD	
	ALTUS
CHAIRMAN DATE	ENGINEERING, INC.
	133 COURT STREET PORTSMOUTH, NH 03801 (603) 433-2335 www.ALTUS-ENG.com
IOTE:	
F SOIL BECOMES COMPATCED OVER THE ROOT ZONE OF ANY TREE, THE GROUND SHOULD BE AERATED BY UNCHING SMALL HOLES IN IT WITH SUITABLE	
ERATING EQUIPMENT. NY DAMAGE TO THE CROWN, TRUNK OR ROOT SYSTEM OF ANY TREE RETAINED ON SITE SHOULD	
RE REPAIRED IMMEDIATELY. CONSULT A FORESTER OR TREE SPECIALIST FOR MORE SERIOUS DAMAGE OF TREES.	
ONTRACTOR TO USE TREE PROTECTION WHERE UITABLE AND/OR AS DIRECTED BY THE ENGINEER.	
	NOT FOR CONSTRUCTION
	ISSUED FOR:
	TAC WORK SESSION
	ISSUE DATE: NOVEMBER 2, 2021
	REVISIONS
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	DRAWN BY:CDB
	APPROVED BY:EDW
	DRAWING FILE:5079-SITE.dwg
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	$\frac{11 \times 17}{0 \text{WNER:}} = 40$
	WENTWORTH CORNER, LLC
	1150 SAGAMORE AVENUE PORTSMOUTH, NH 03801
	APPLICANT:
	KATZ DEVELOPMENT
	CORPORATION
	273 CORPORATE DRIVE PORTSMOUTH, NH 03801
2" × 2" WOODEN STAKE (TYP.);	
REBAR W/ORANGE SAFETY CAP MAY BE USED IN	<u>PROJECT:</u> PROPOSED MULTI-FAMILY
AR PAVED SURFACE ONLY	RESIDENTIAL
3"-4"	DEVELOPMENT TAX MAP 201
EA AREA TO BE PROTECTED	LOT 2 SAGAMORE ROAD
	PORTSMOUTH, NH 03801
12"	
	<u>TITLE:</u>
SECTION	
	CONSTRUCTION
SECTION PLAR SEDIMENT BARRIERS. STED AS NECESSARY TO MEET THE	CONSTRUCTION DETAILS
ULAR SEDIMENT BARRIERS. STED AS NECESSARY TO MEET THE OF PROPERLY.	
ILAR SEDIMENT BARRIERS. STED AS NECESSARY TO MEET THE	DETAILS SHEET NUMBER:

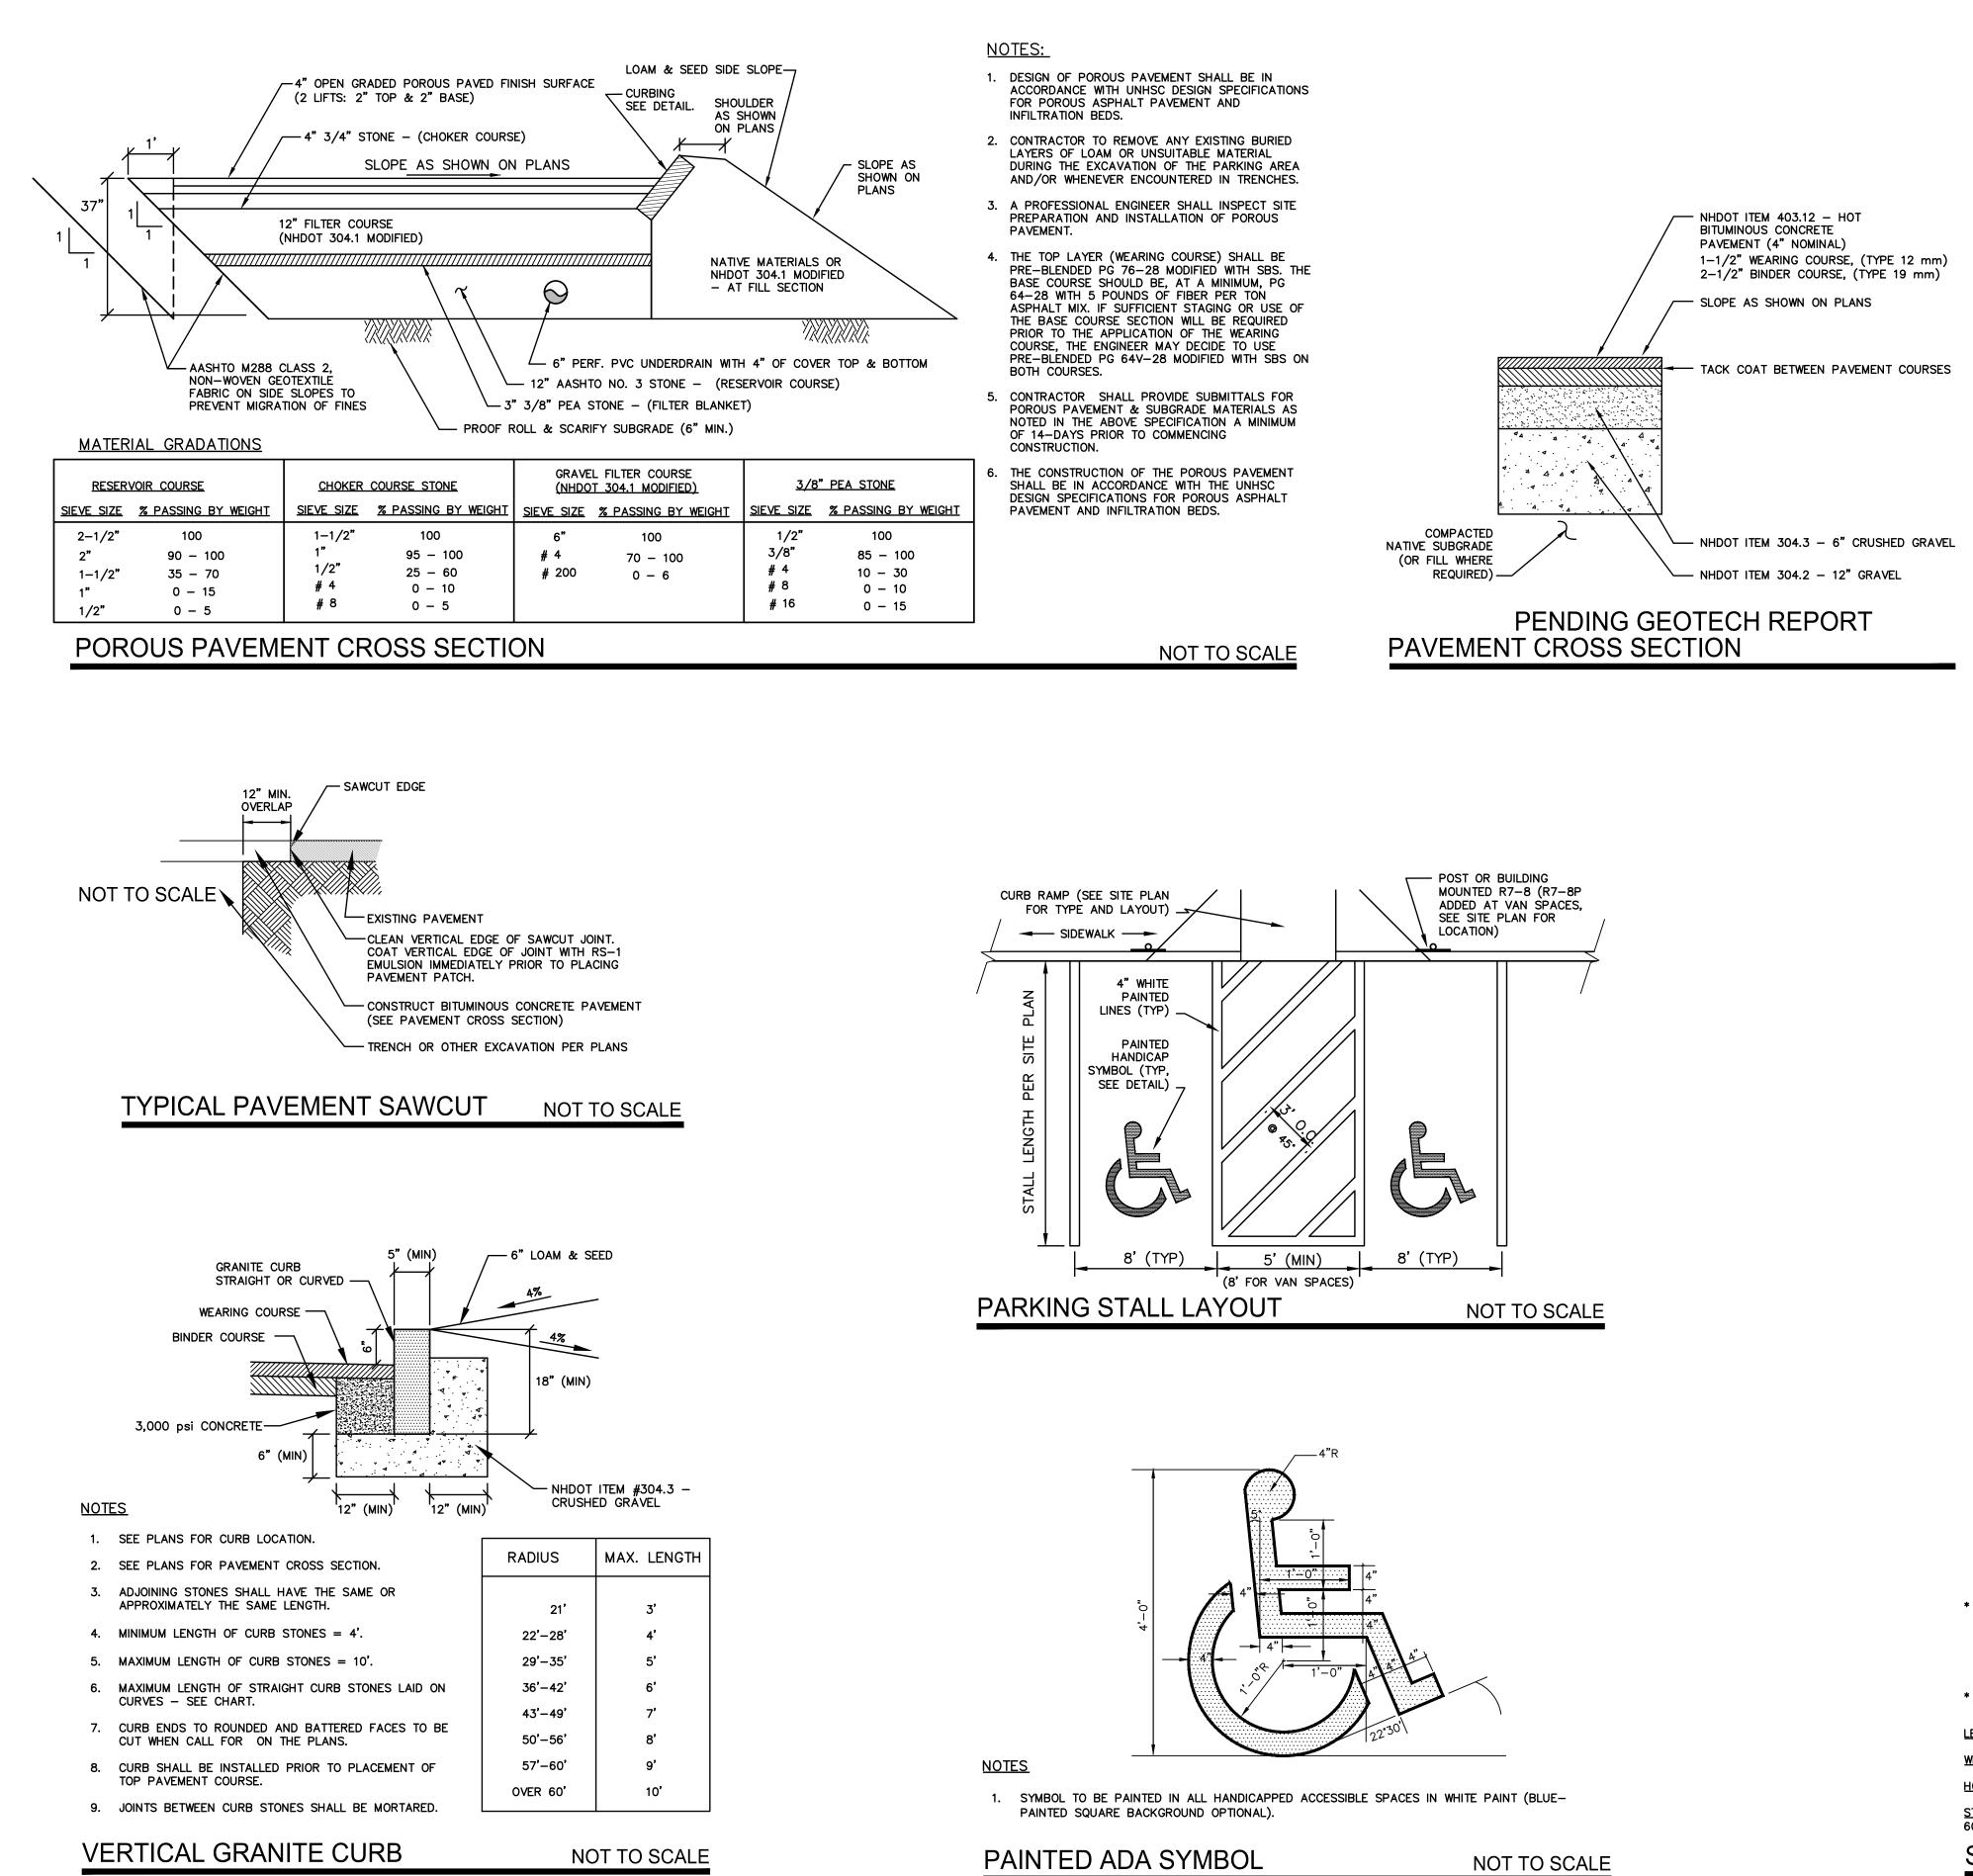


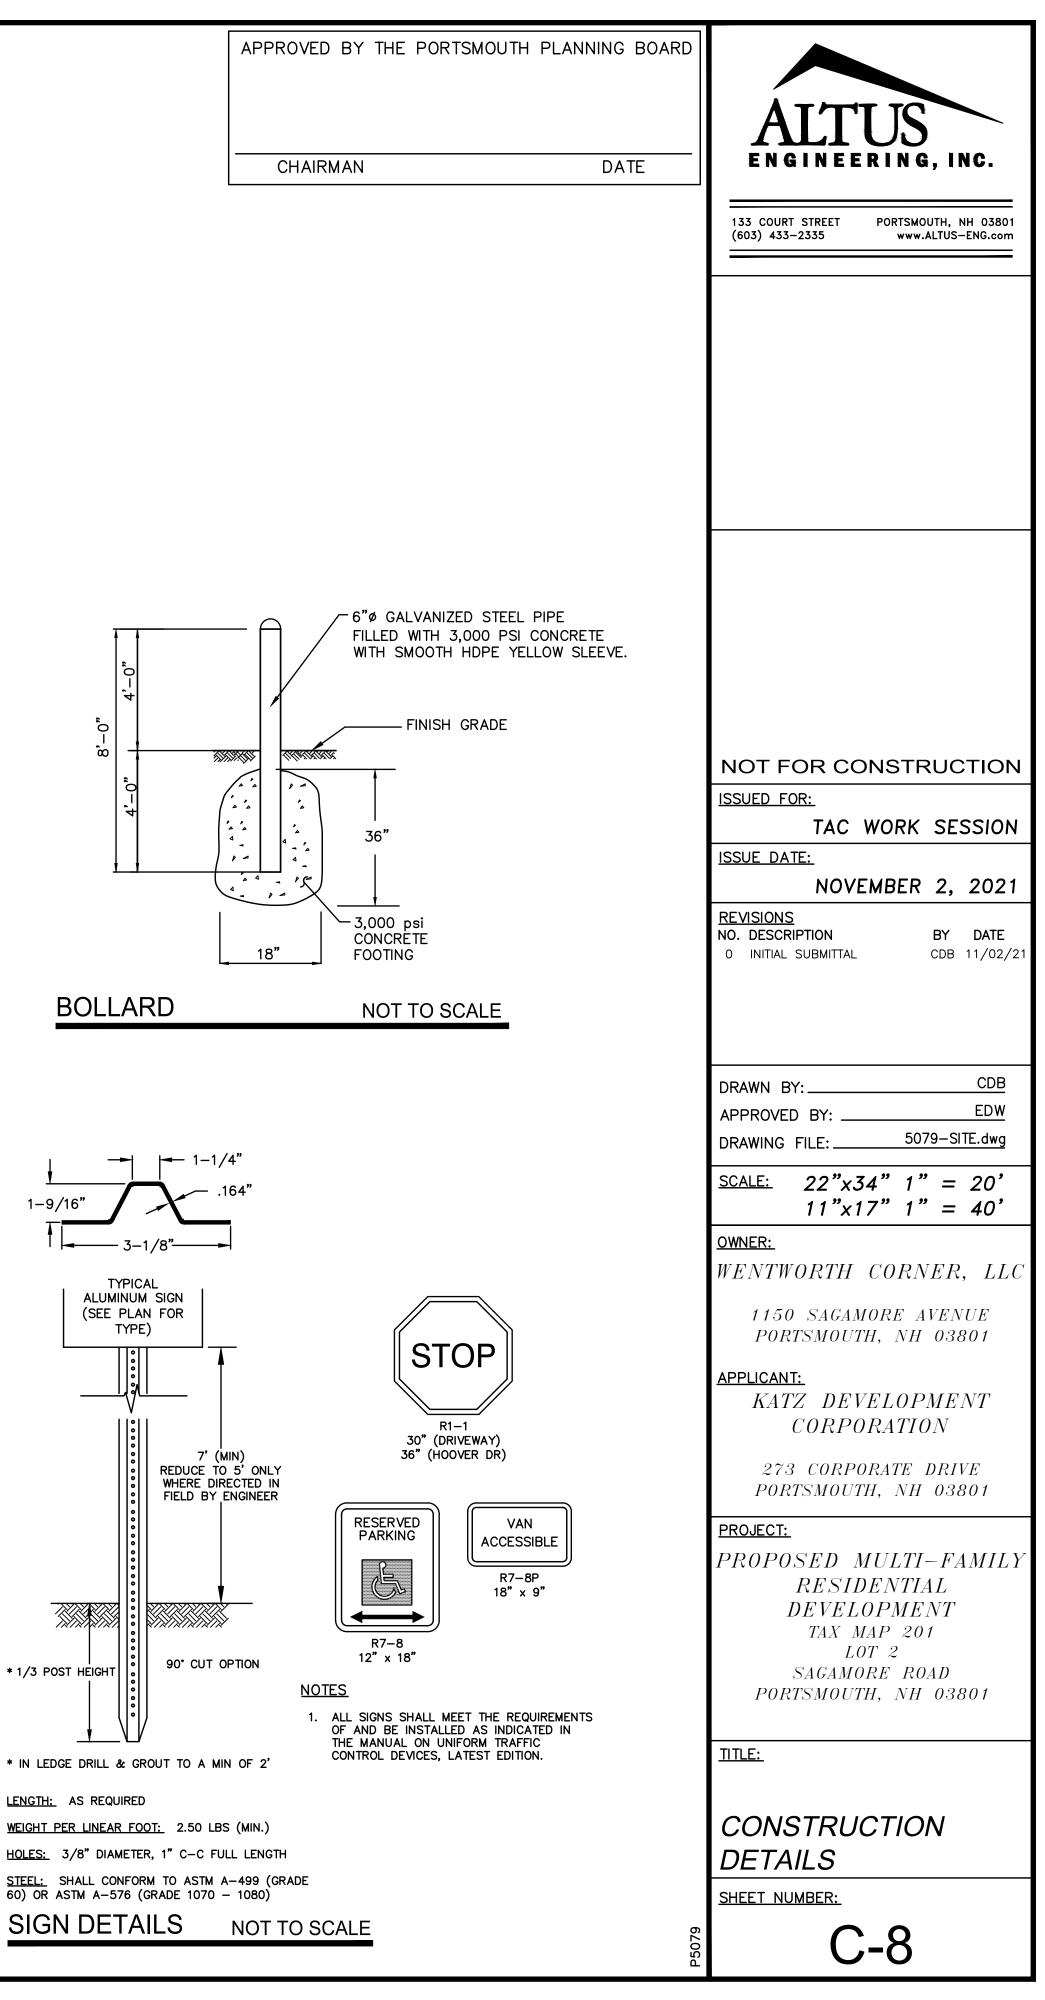





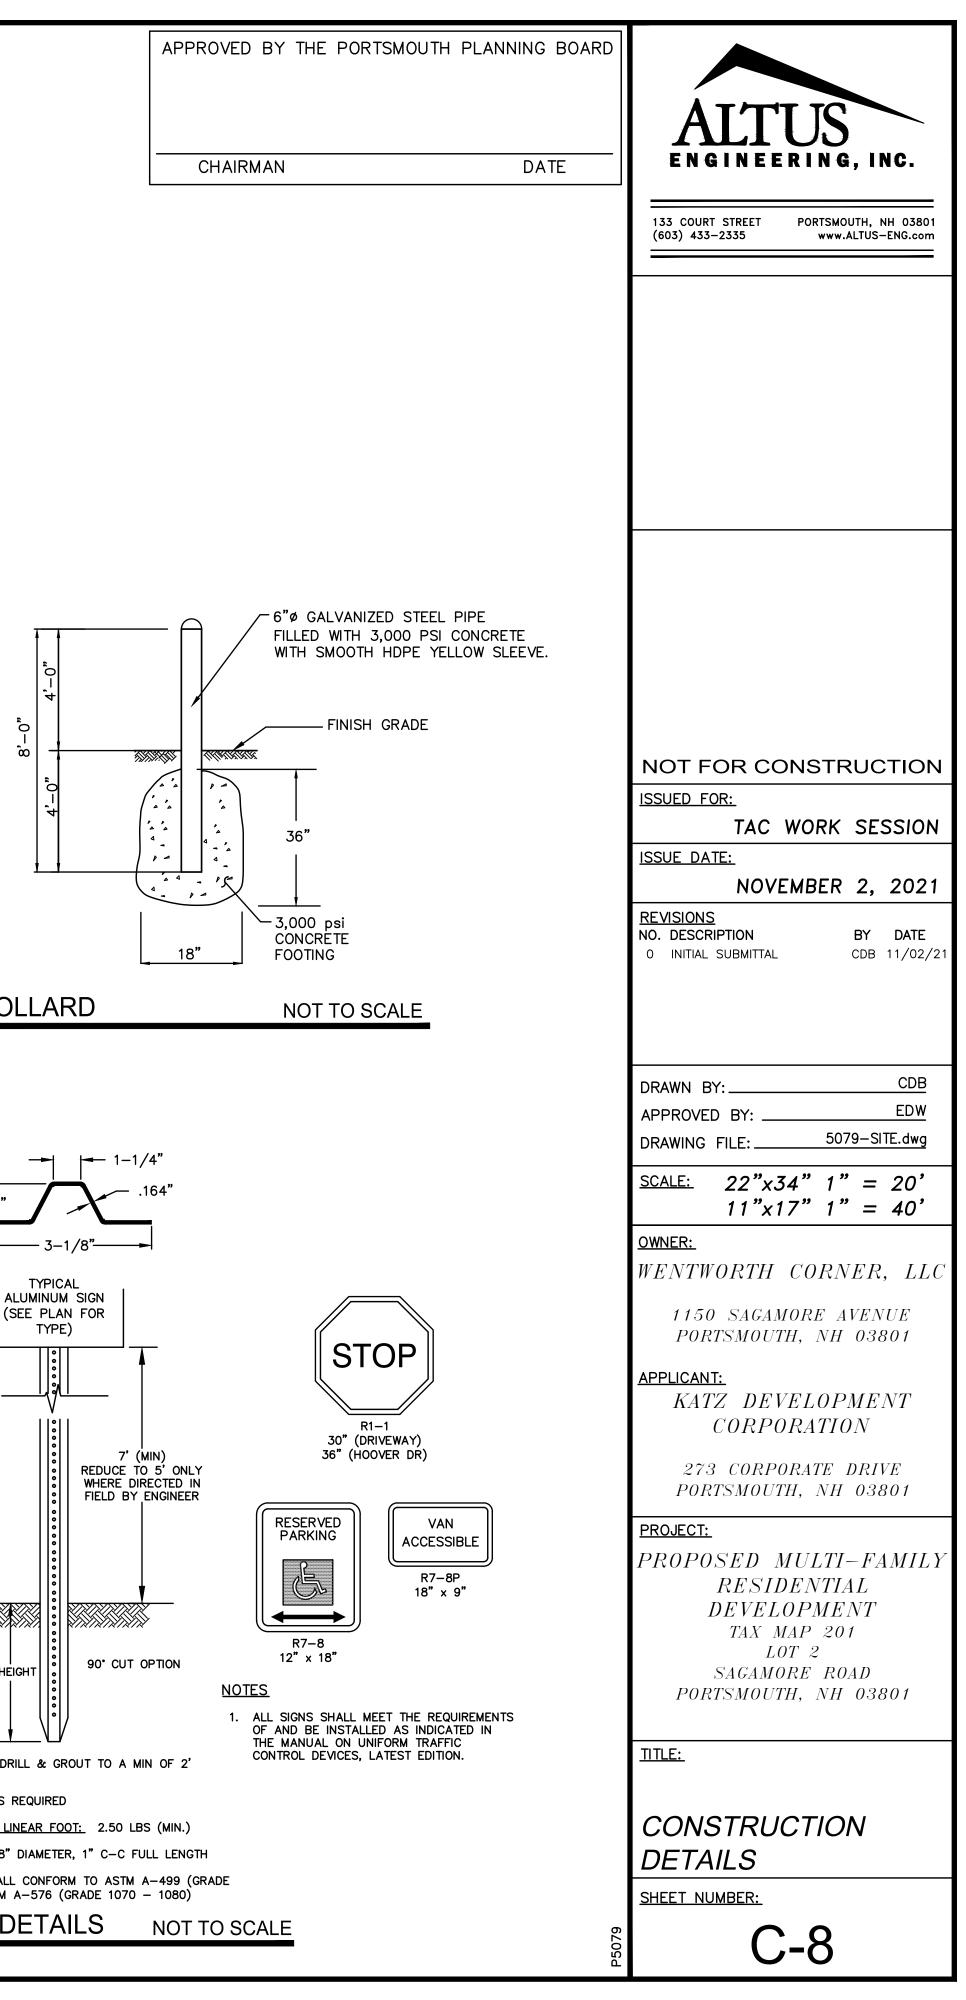

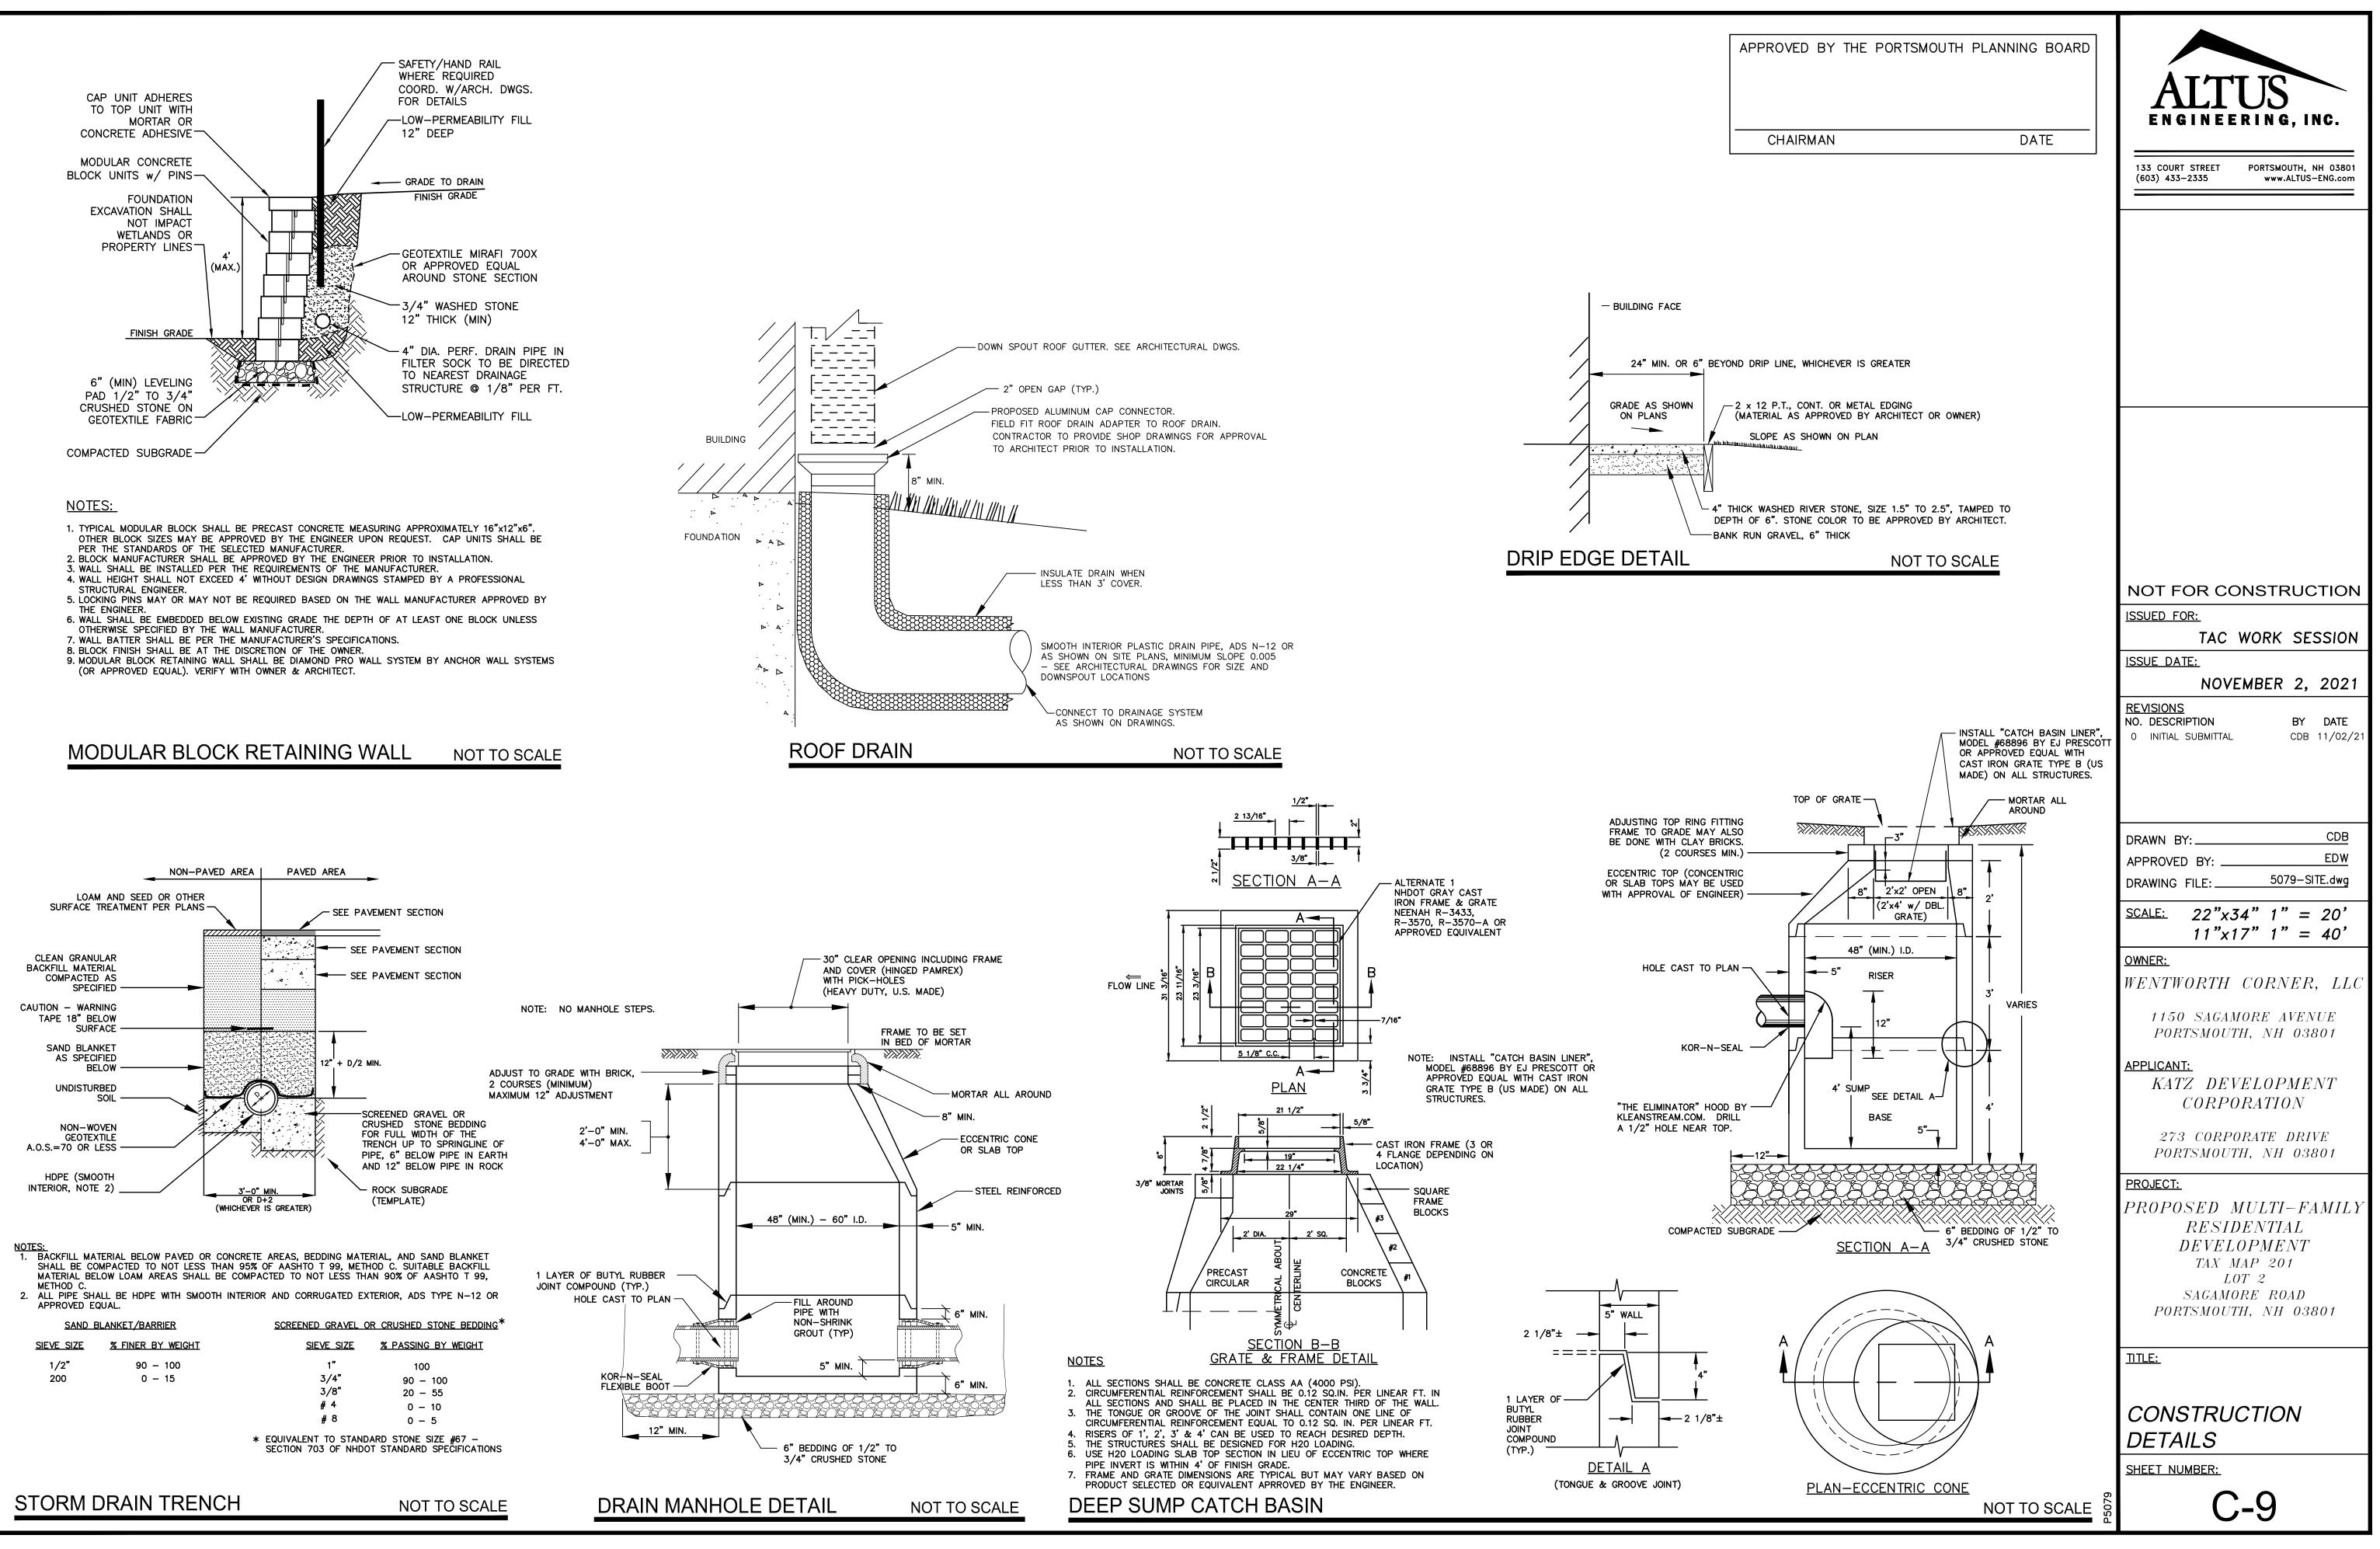

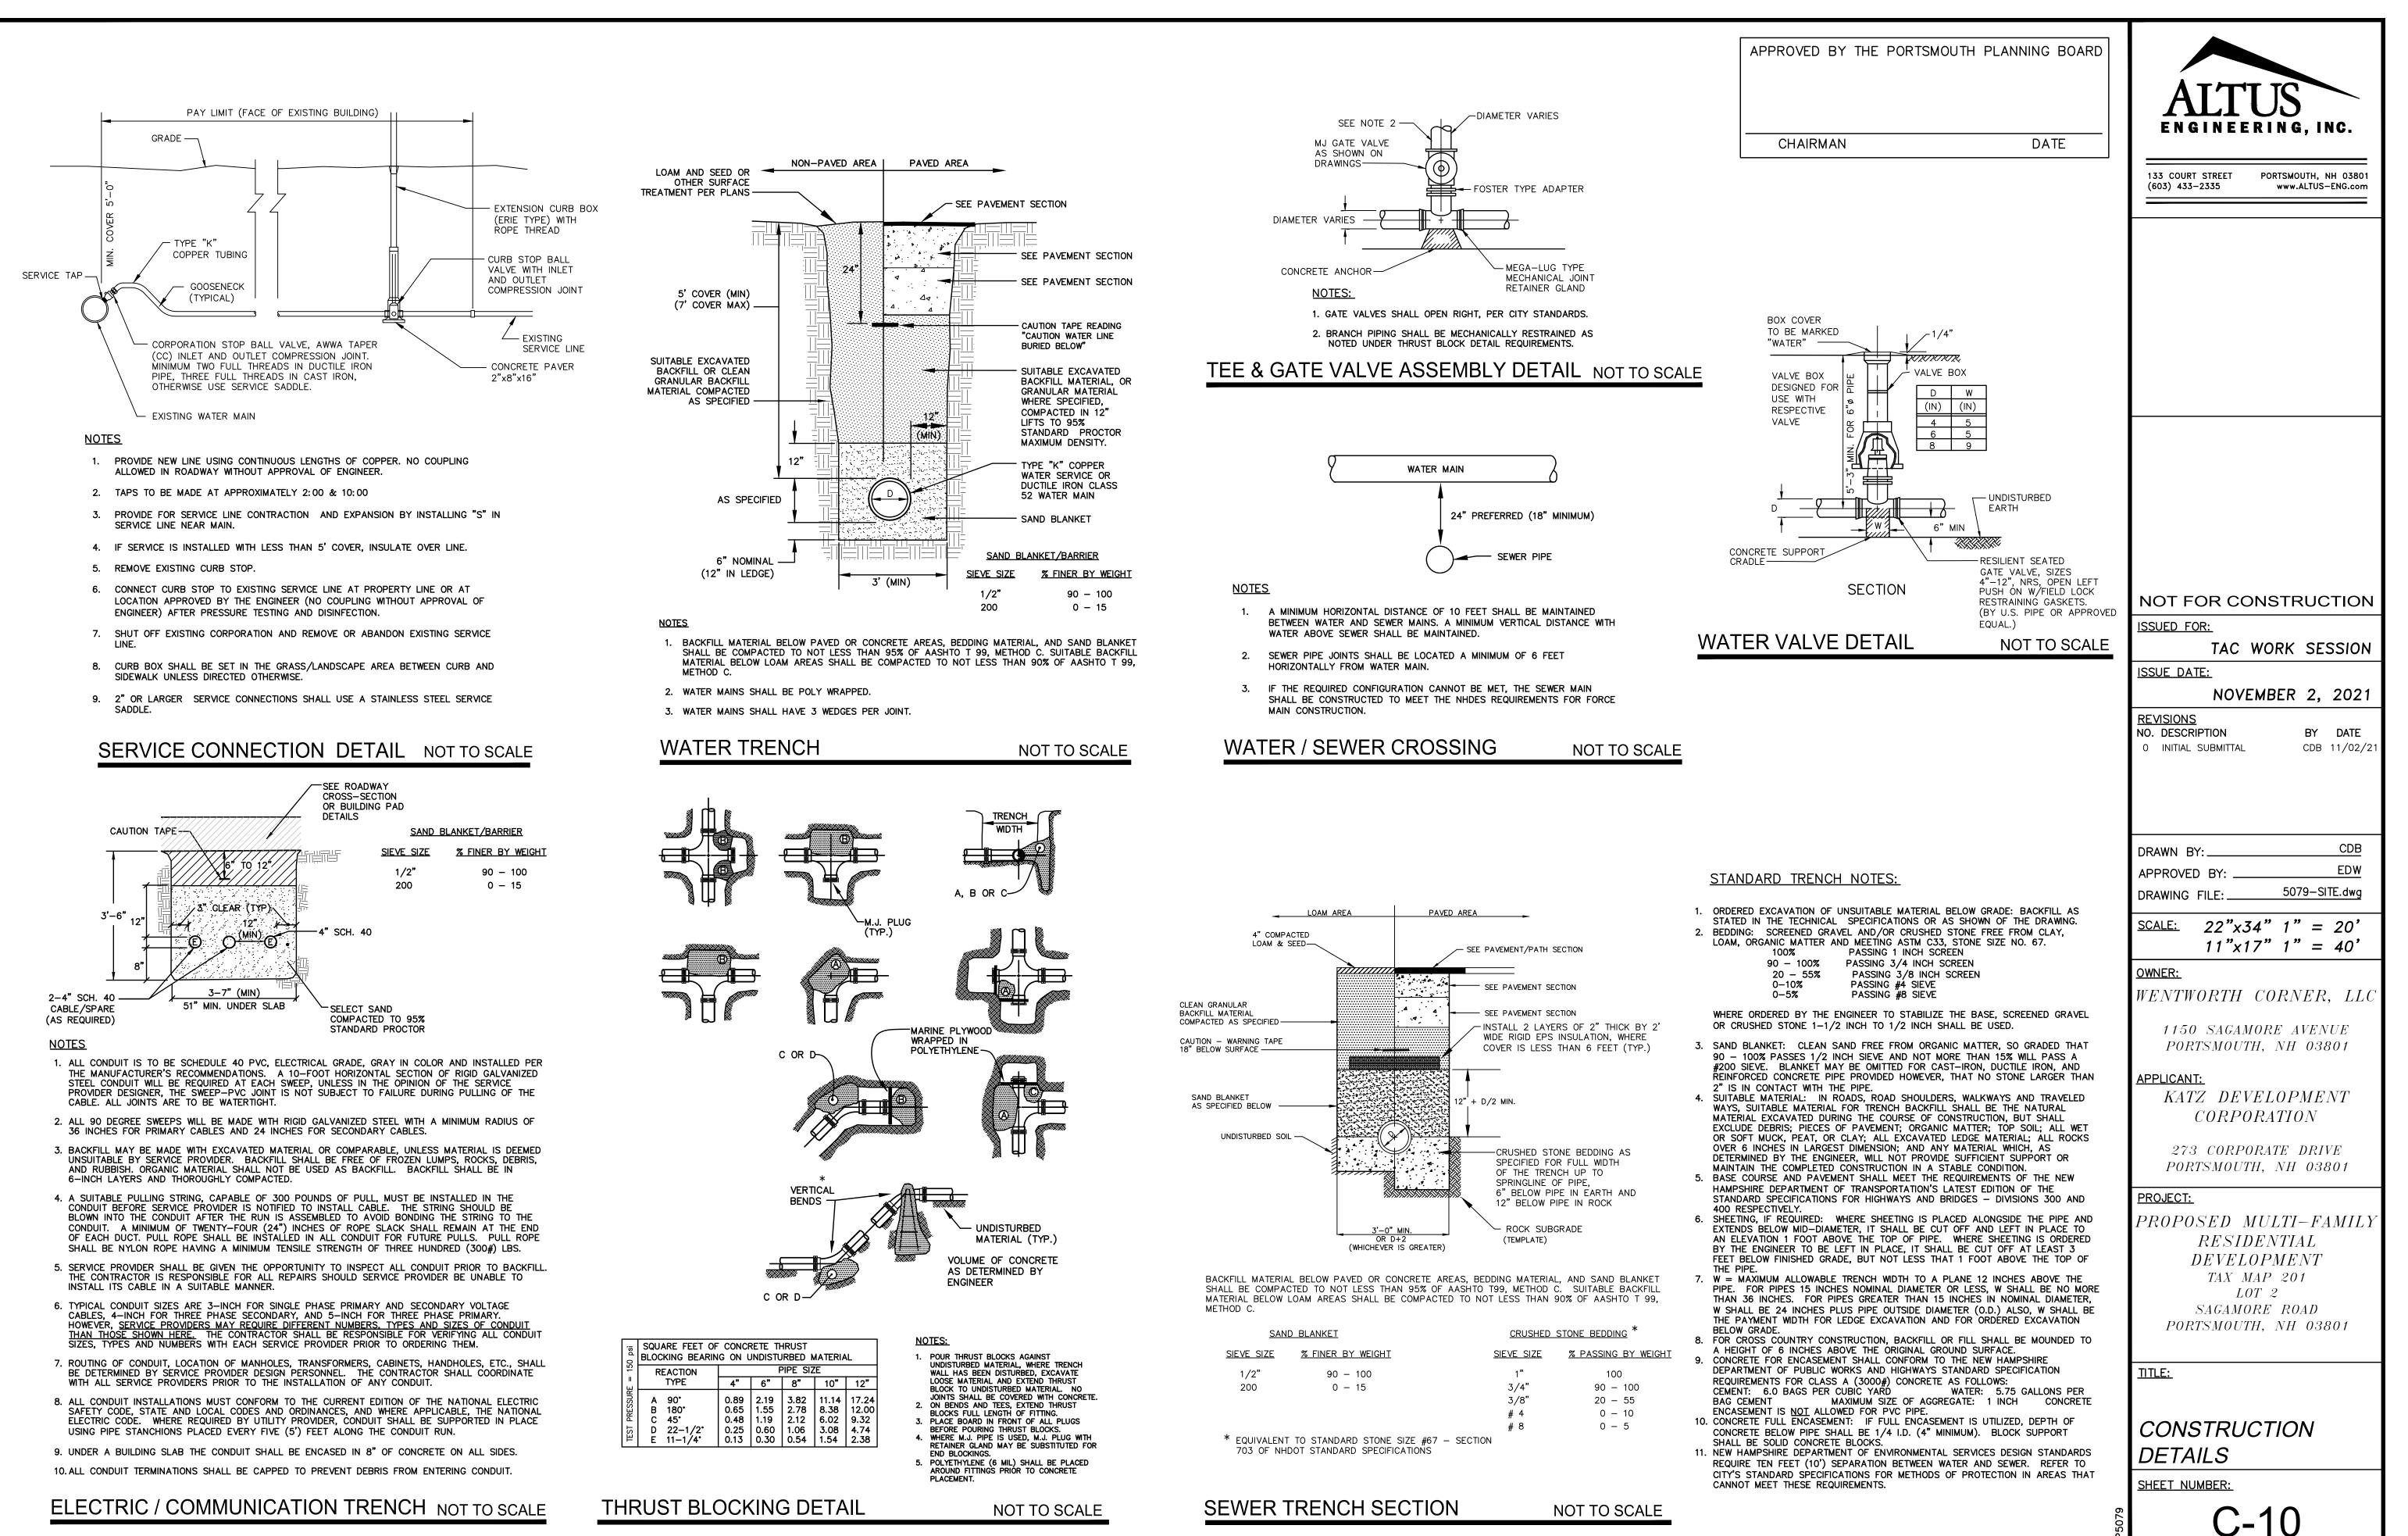


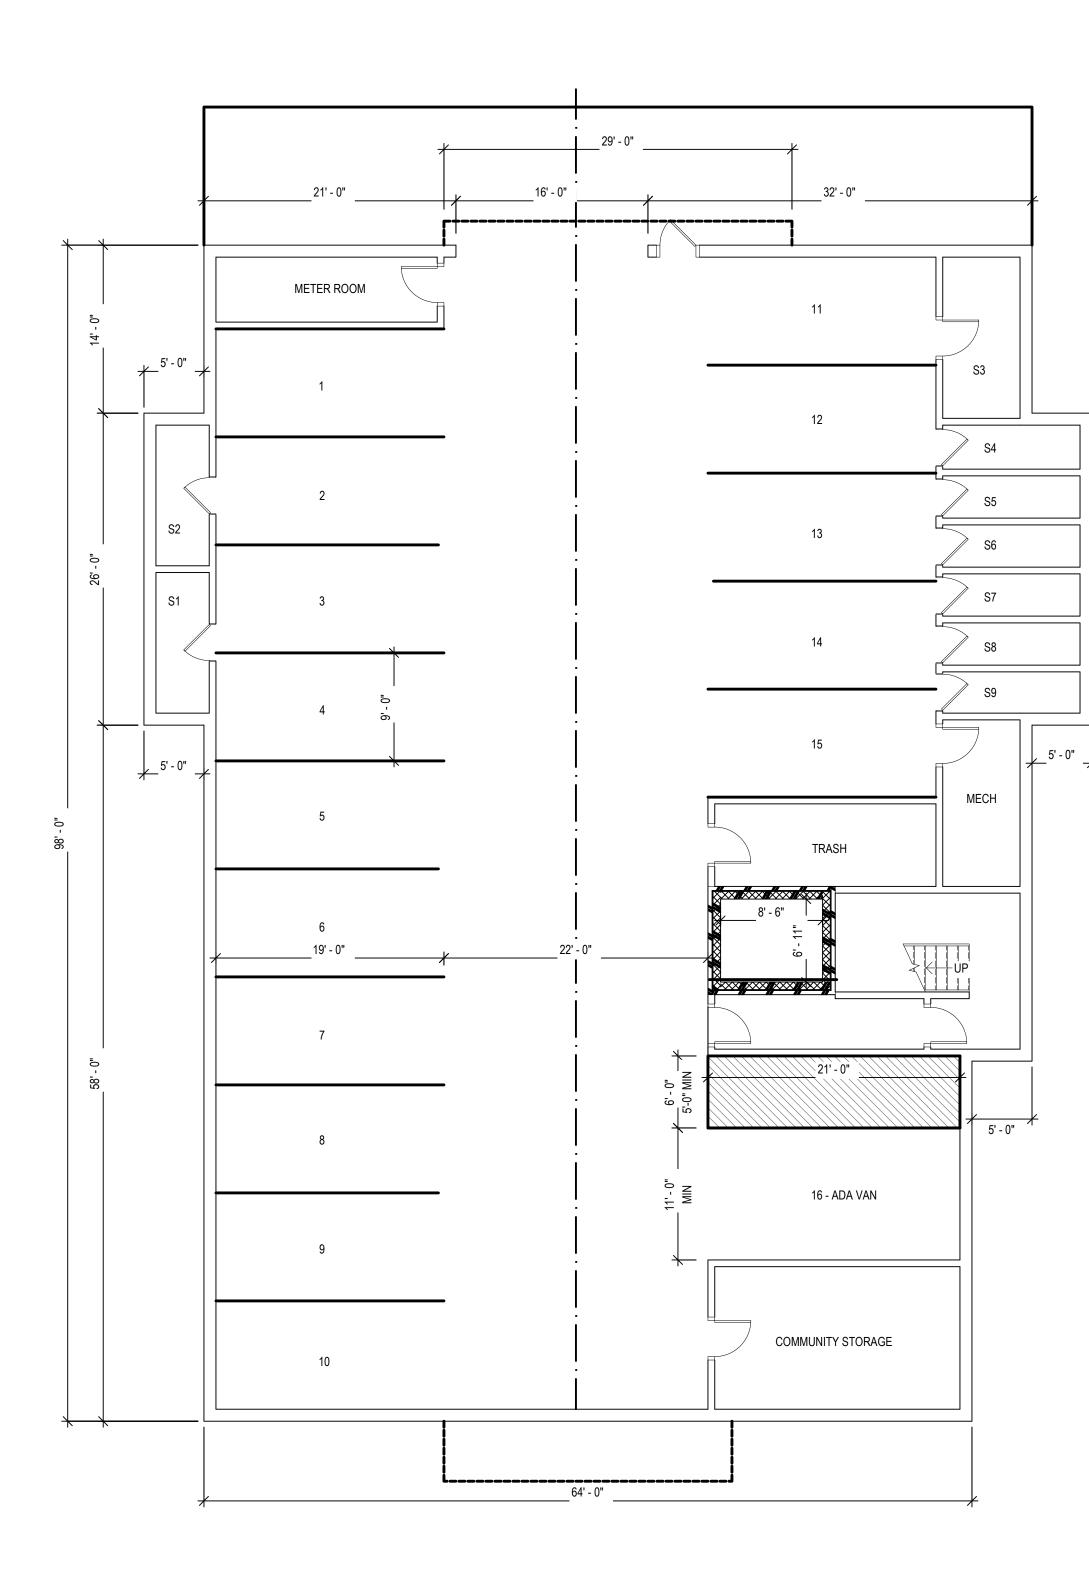

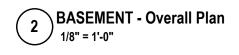




1 LEVEL 1 - Overall Plan 1/8" = 1'-0"

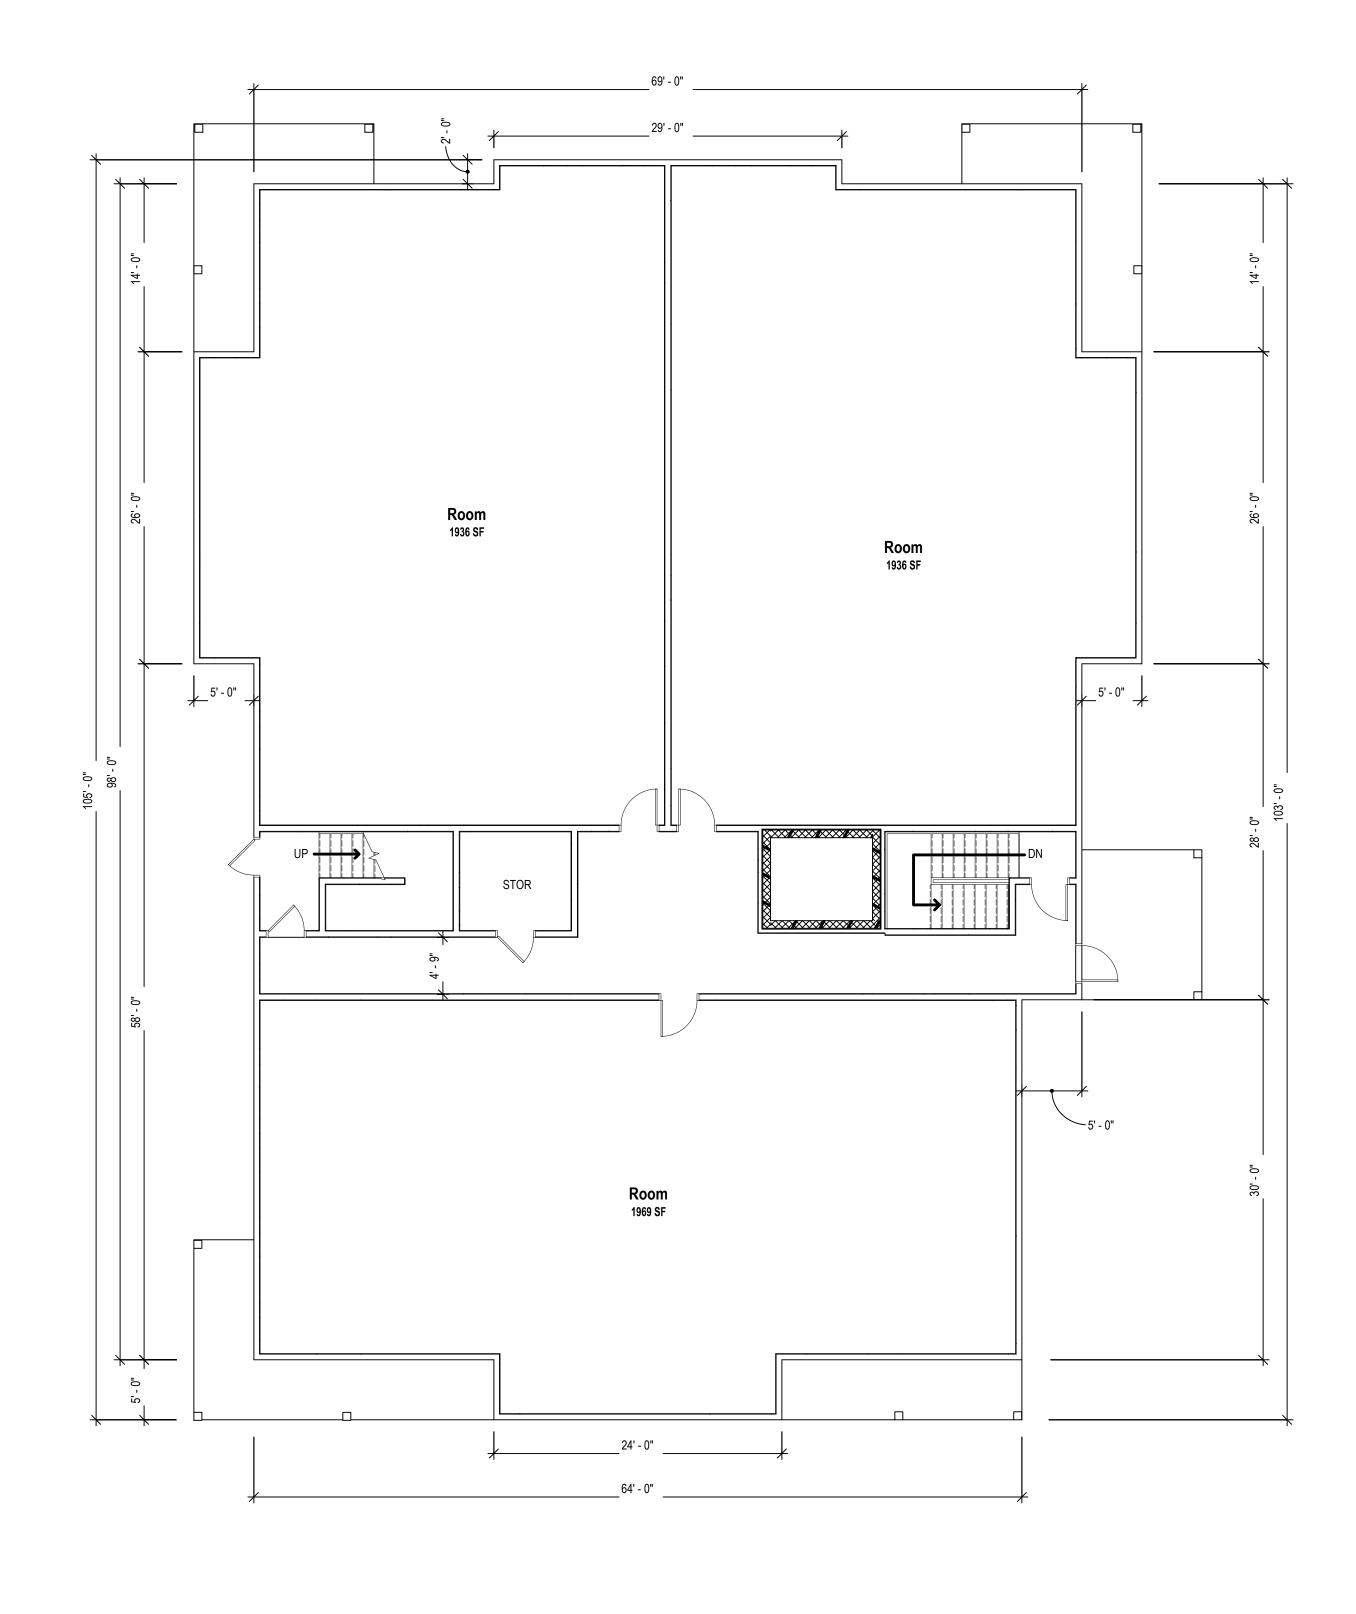






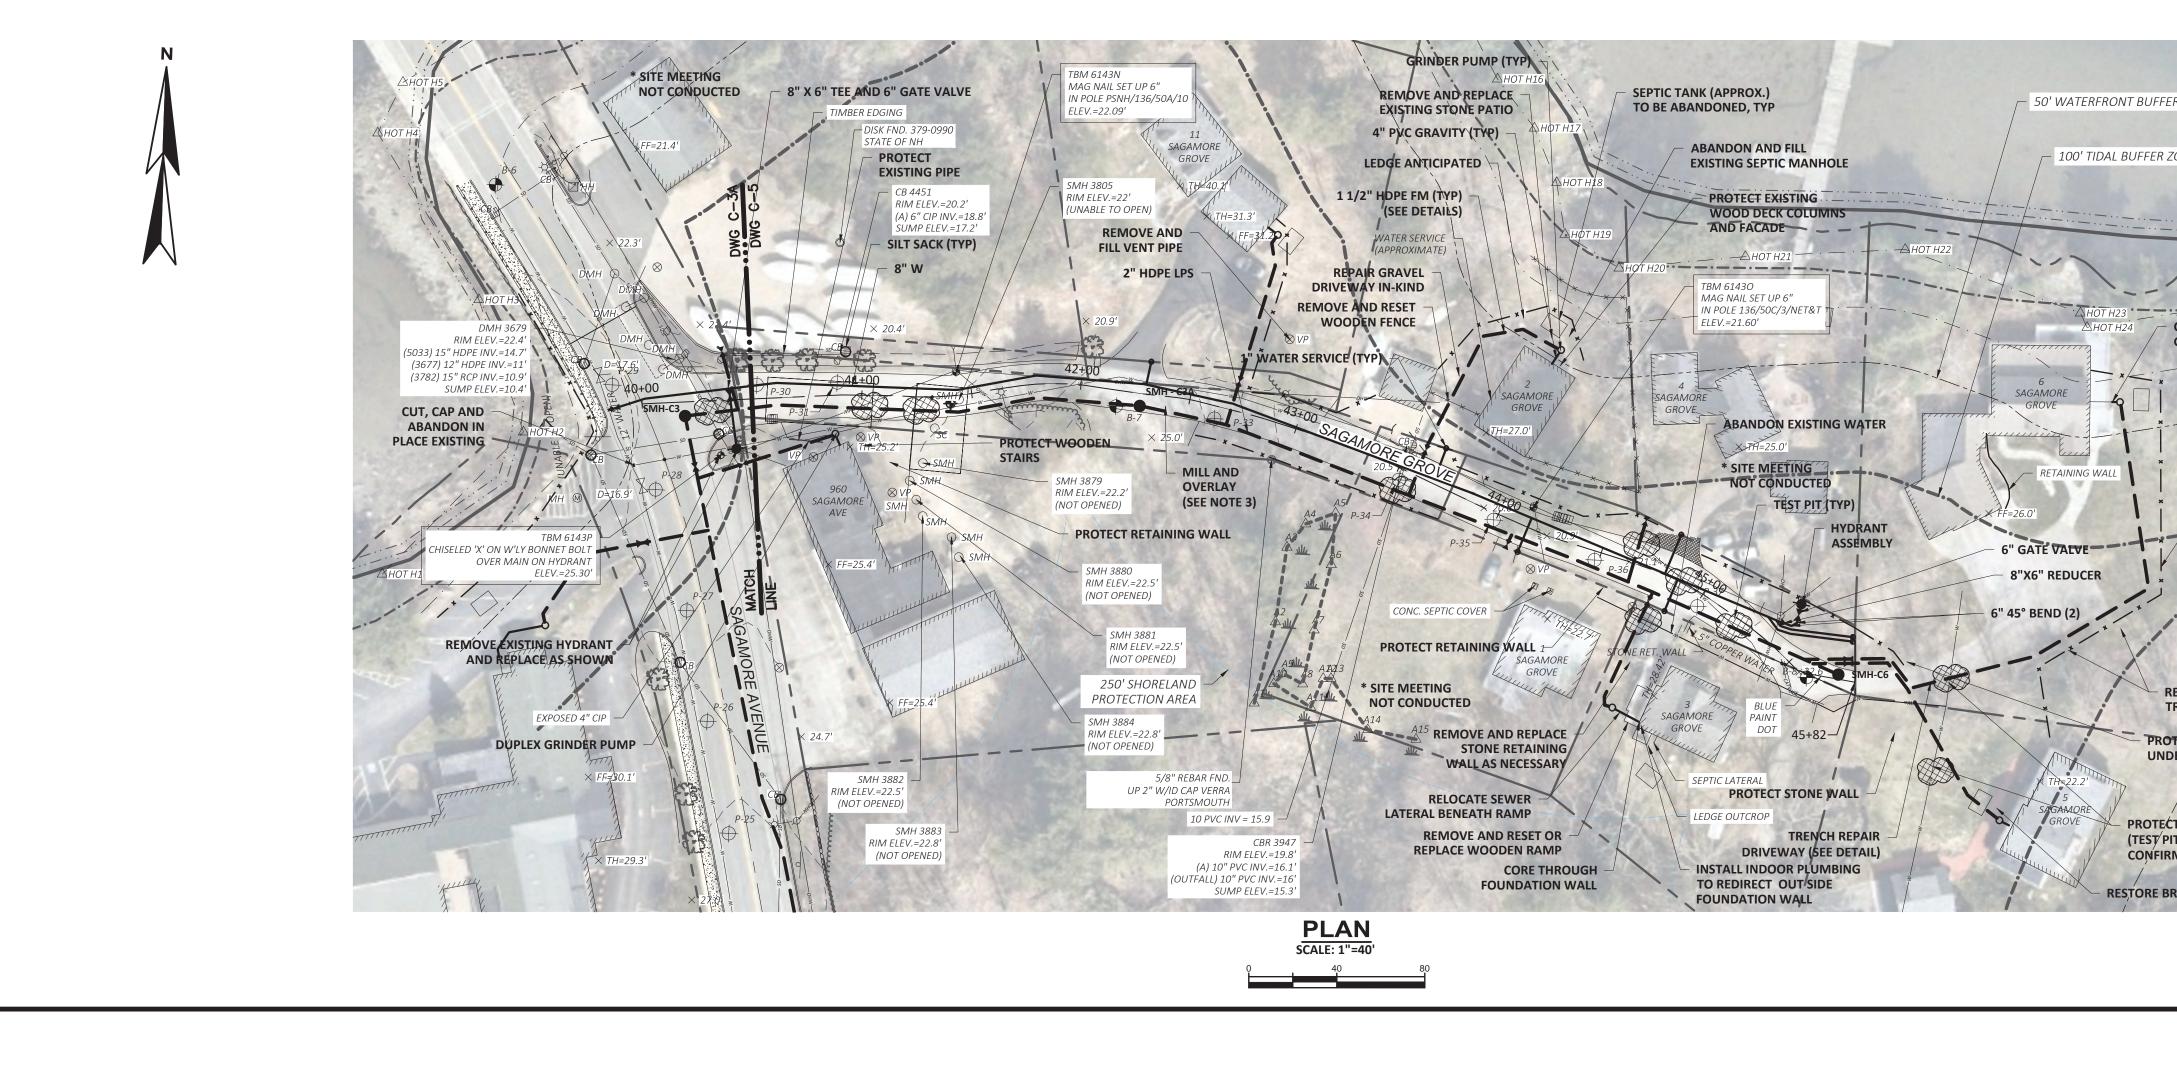



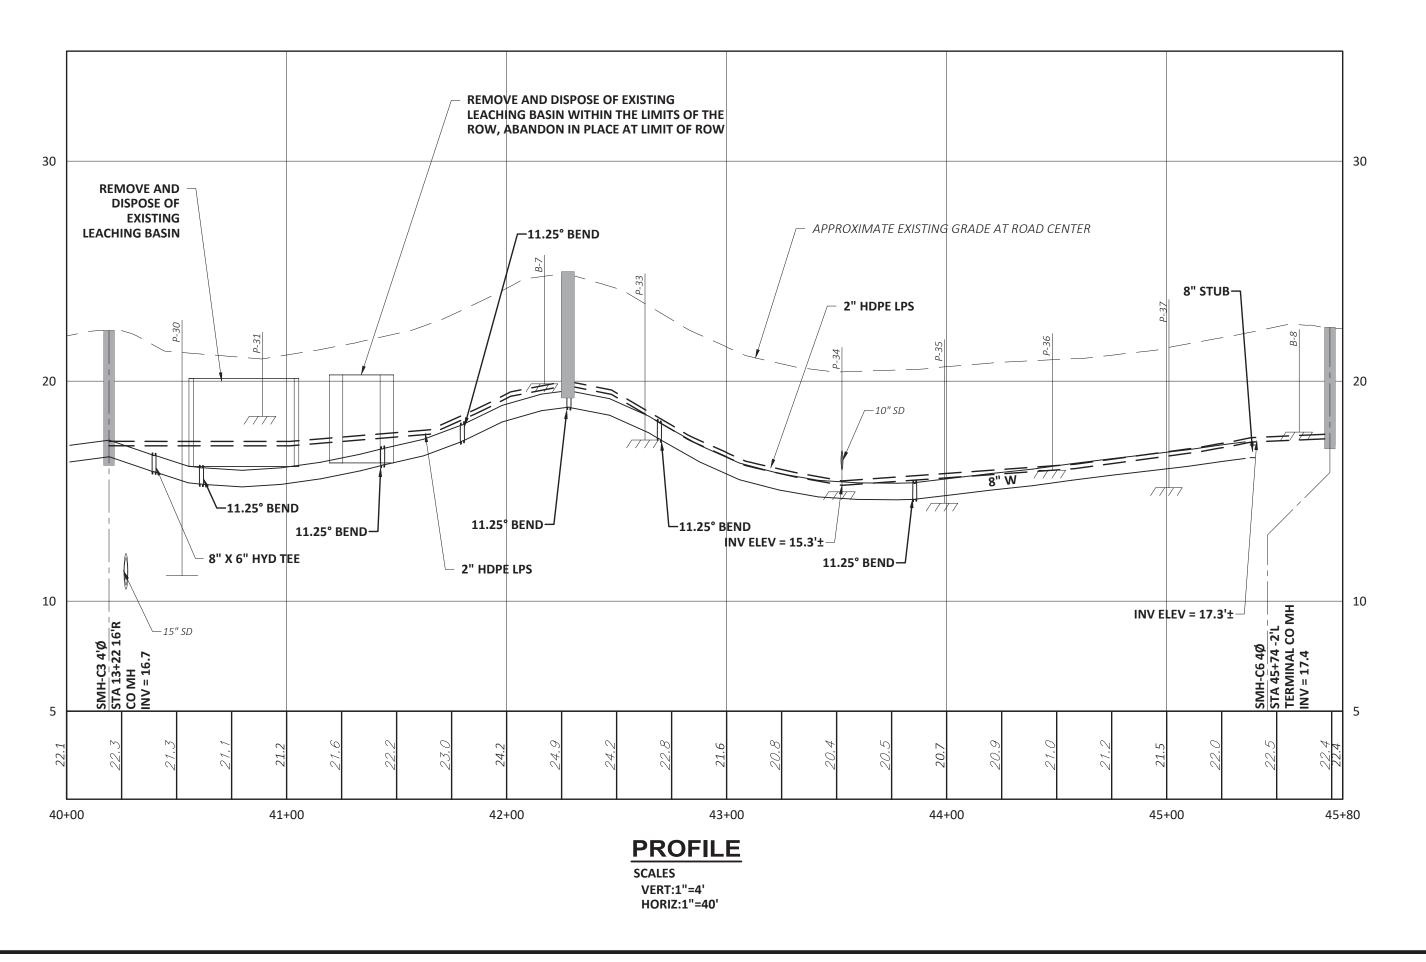

NOTES:

1. WORK OUTSIDE CITY OWNED EASEMENTS AND RIGHTS OF WAY ARE NOT AUTHORIZED UNTIL HOMEOWNER AND CITY SIGN OFFS ARE EXECUTED.

2. ALL AREAS (EXCEPT GRAVEL DRIVEWAYS) THAT ARE EXCAVATED, FILLED OR OTHERWISE DISTURBED BY THE CONTRACTOR AND ARE NOT TO BE PAVED OR FILLED WITH GRAVEL OR RIPRAP SHALL BE LOAMED, GRADED, FERTILIZED, SEEDED AND MULCHED. ALL AREAS ARE TO RECEIVE A MINIMUM OF 6" OF TOPSOIL. REFER TO SPECIFICATION SECTION 02480.

3. SEE DETAIL SHEETS FOR PAVING RECOMMENDATIONS.

DER GROUND EFECTRICAL		
CT WATER PTS TO RM LOCATION) BRICK WALKWAY HOT HAIL WAL HOT HAIL WAL		888.621.8156 www.wright-pierce.com
CITY OF PORTSMOUTH, NH		PLAN AND PROFILE: SAGAMORE GROVE (STA 40+00 TO STA 45+80)
DRAFT	RAWI C-5	NG